


BASEMENT WINDOW SCHEDULE				
Type Mark	Type	Sill Height	Head Height	Comments
K	Casement 36" x 60"	2' - 0"	7' - 0"	
K	Casement 36" x 60"	2' - 0"	7' - 0"	
K	Casement 36" x 60"	2' - 0"	7' - 0"	
L	Fixed 36" x 60"	2' - 0"	7' - 0"	
L	Fixed 36" x 60"	2' - 0"	7' - 0"	
M	Fixed 60" x 48"	3' - 0"	7' - 0"	
M	Fixed 60" x 48"	3' - 0"	7' - 0"	

Grand total: 7

BASEMENT DOOR SCHEDULE				
Construction Type	Type	Width	Height	Comments
3070 Slider	72" x 84"	6' - 0"	7' - 0"	
3068	36" x 80"	3' - 0"	6' - 8"	

Grand total: 2

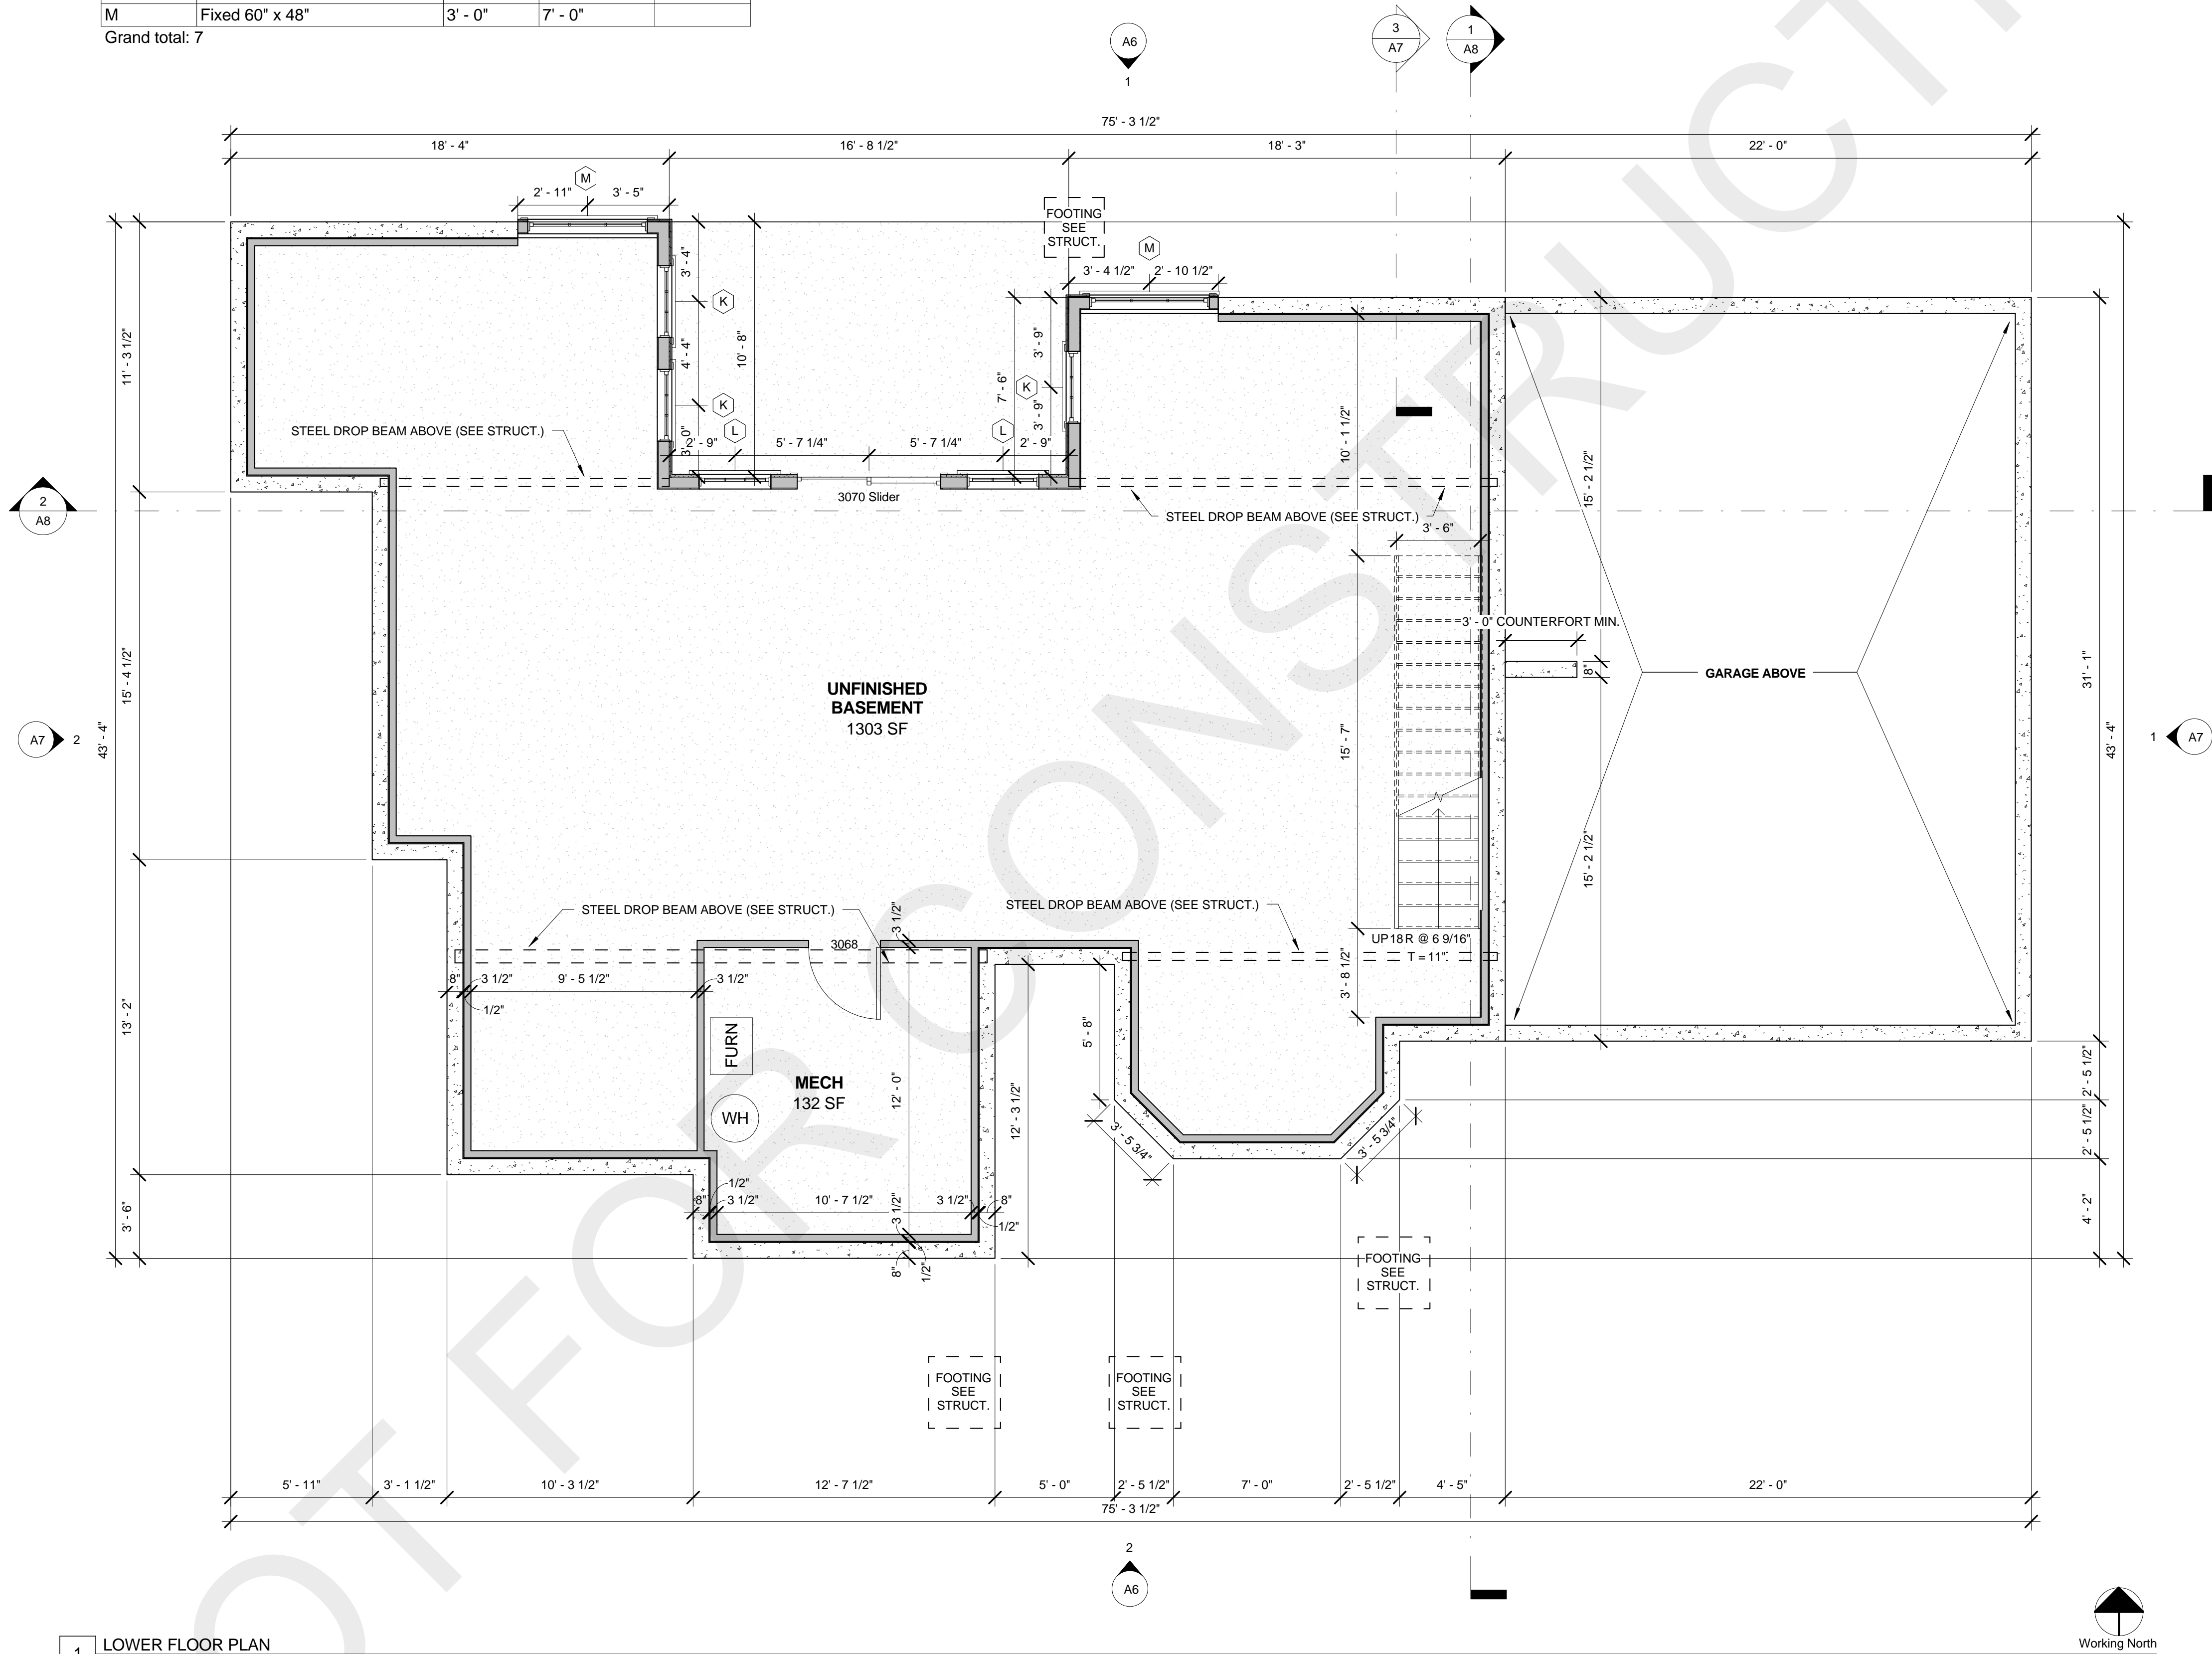

1 LOWER FLOOR PLAN
1/4" = 1'-0"



Drawn by AAA
Checked by BBB
Project Date 00/00/2000
Project Number 000000


BUILDERS SET
John Doe Lane John Doe Town, John State 00000

MAIN FLOOR WINDOW SCHEDULE				
Type Mark	Type	Sill Height	Head Height	Comments
A	Fixed 48" x 48"	2' - 0"	6' - 0"	
B	Fixed 48" x 24"	6' - 0"	8' - 0"	
C	Fixed 60" x 48"	2' - 0"	6' - 0"	
D	Fixed 60" x 24"	6' - 0"	8' - 0"	
E	Fixed 30" x 48"	2' - 0"	6' - 0"	
E	Fixed 30" x 48"	2' - 0"	6' - 0"	
F	Fixed 30" x 24"	6' - 0"	8' - 0"	
F	Fixed 30" x 24"	6' - 0"	8' - 0"	
G	Slider 72" x 60"	3' - 0"	8' - 0"	
G	Slider 72" x 60"	3' - 0"	8' - 0"	
G	Slider 72" x 60"	3' - 0"	8' - 0"	
H	Slider 48" x 48"	4' - 0"	8' - 0"	FROSTED GLASS

MAIN FLOOR WINDOW SCHEDULE				
Type Mark	Type	Sill Height	Head Height	Comments
J	Casement 30" x 60"	3' - 0"	8' - 0"	
K	Casement 36" x 60"	3' - 0"	8' - 0"	
K	Casement 36" x 60"	3' - 0"	8' - 0"	
K	Casement 36" x 60"	3' - 0"	8' - 0"	
K	Casement 36" x 60"	3' - 0"	8' - 0"	
K	Casement 36" x 60"	3' - 0"	8' - 0"	
K	Casement 36" x 60"	3' - 0"	8' - 0"	
L	Fixed 36" x 60"	3' - 0"	8' - 0"	
L	Fixed 36" x 60"	3' - 0"	8' - 0"	
L	Fixed 36" x 60"	3' - 0"	8' - 0"	
Grand total: 23				

MAIN FLOOR DOOR SCHEDULE				
Construction Type	Type	Width	Height	Comments
8' X 7' OVERHEAD GARAGE DOOR	8' x 8'	8' - 0"	8' - 0"	
16' X 8' OVERHEAD GARAGE DOOR	16' x 8'	16' - 0"	8' - 0"	
2468	28" x 80"	2' - 4"	6' - 8"	
2468	28" x 80"	2' - 4"	6' - 8"	
2668	30" x 80"	2' - 6"	6' - 8"	
2668	30" x 80"	2' - 6"	6' - 8"	
2668	30" x 80"	2' - 6"	6' - 8"	

MAIN FLOOR DOOR SCHEDULE				
Construction Type	Type	Width	Height	Comments
2668	30" x 80"	2' - 6"	6' - 8"	
2668	30" x 80"	2' - 6"	6' - 8"	
2668	30" x 80"	2' - 6"	6' - 8"	
3068	36" x 80"	3' - 0"	6' - 8"	
3068	36" x 80"	3' - 0"	6' - 8"	
3068 GLASS	36" x 80"	3' - 0"	6' - 8"	
3080 GLASS	36" x 96"	3' - 0"	8' - 0"	
3668	42" x 80"	3' - 6"	6' - 8"	
4068 SLIDER	48" x 80"	4' - 0"	6' - 8"	
5068 SLIDER	60" x 80"	5' - 0"	6' - 8"	
Grand total: 17				

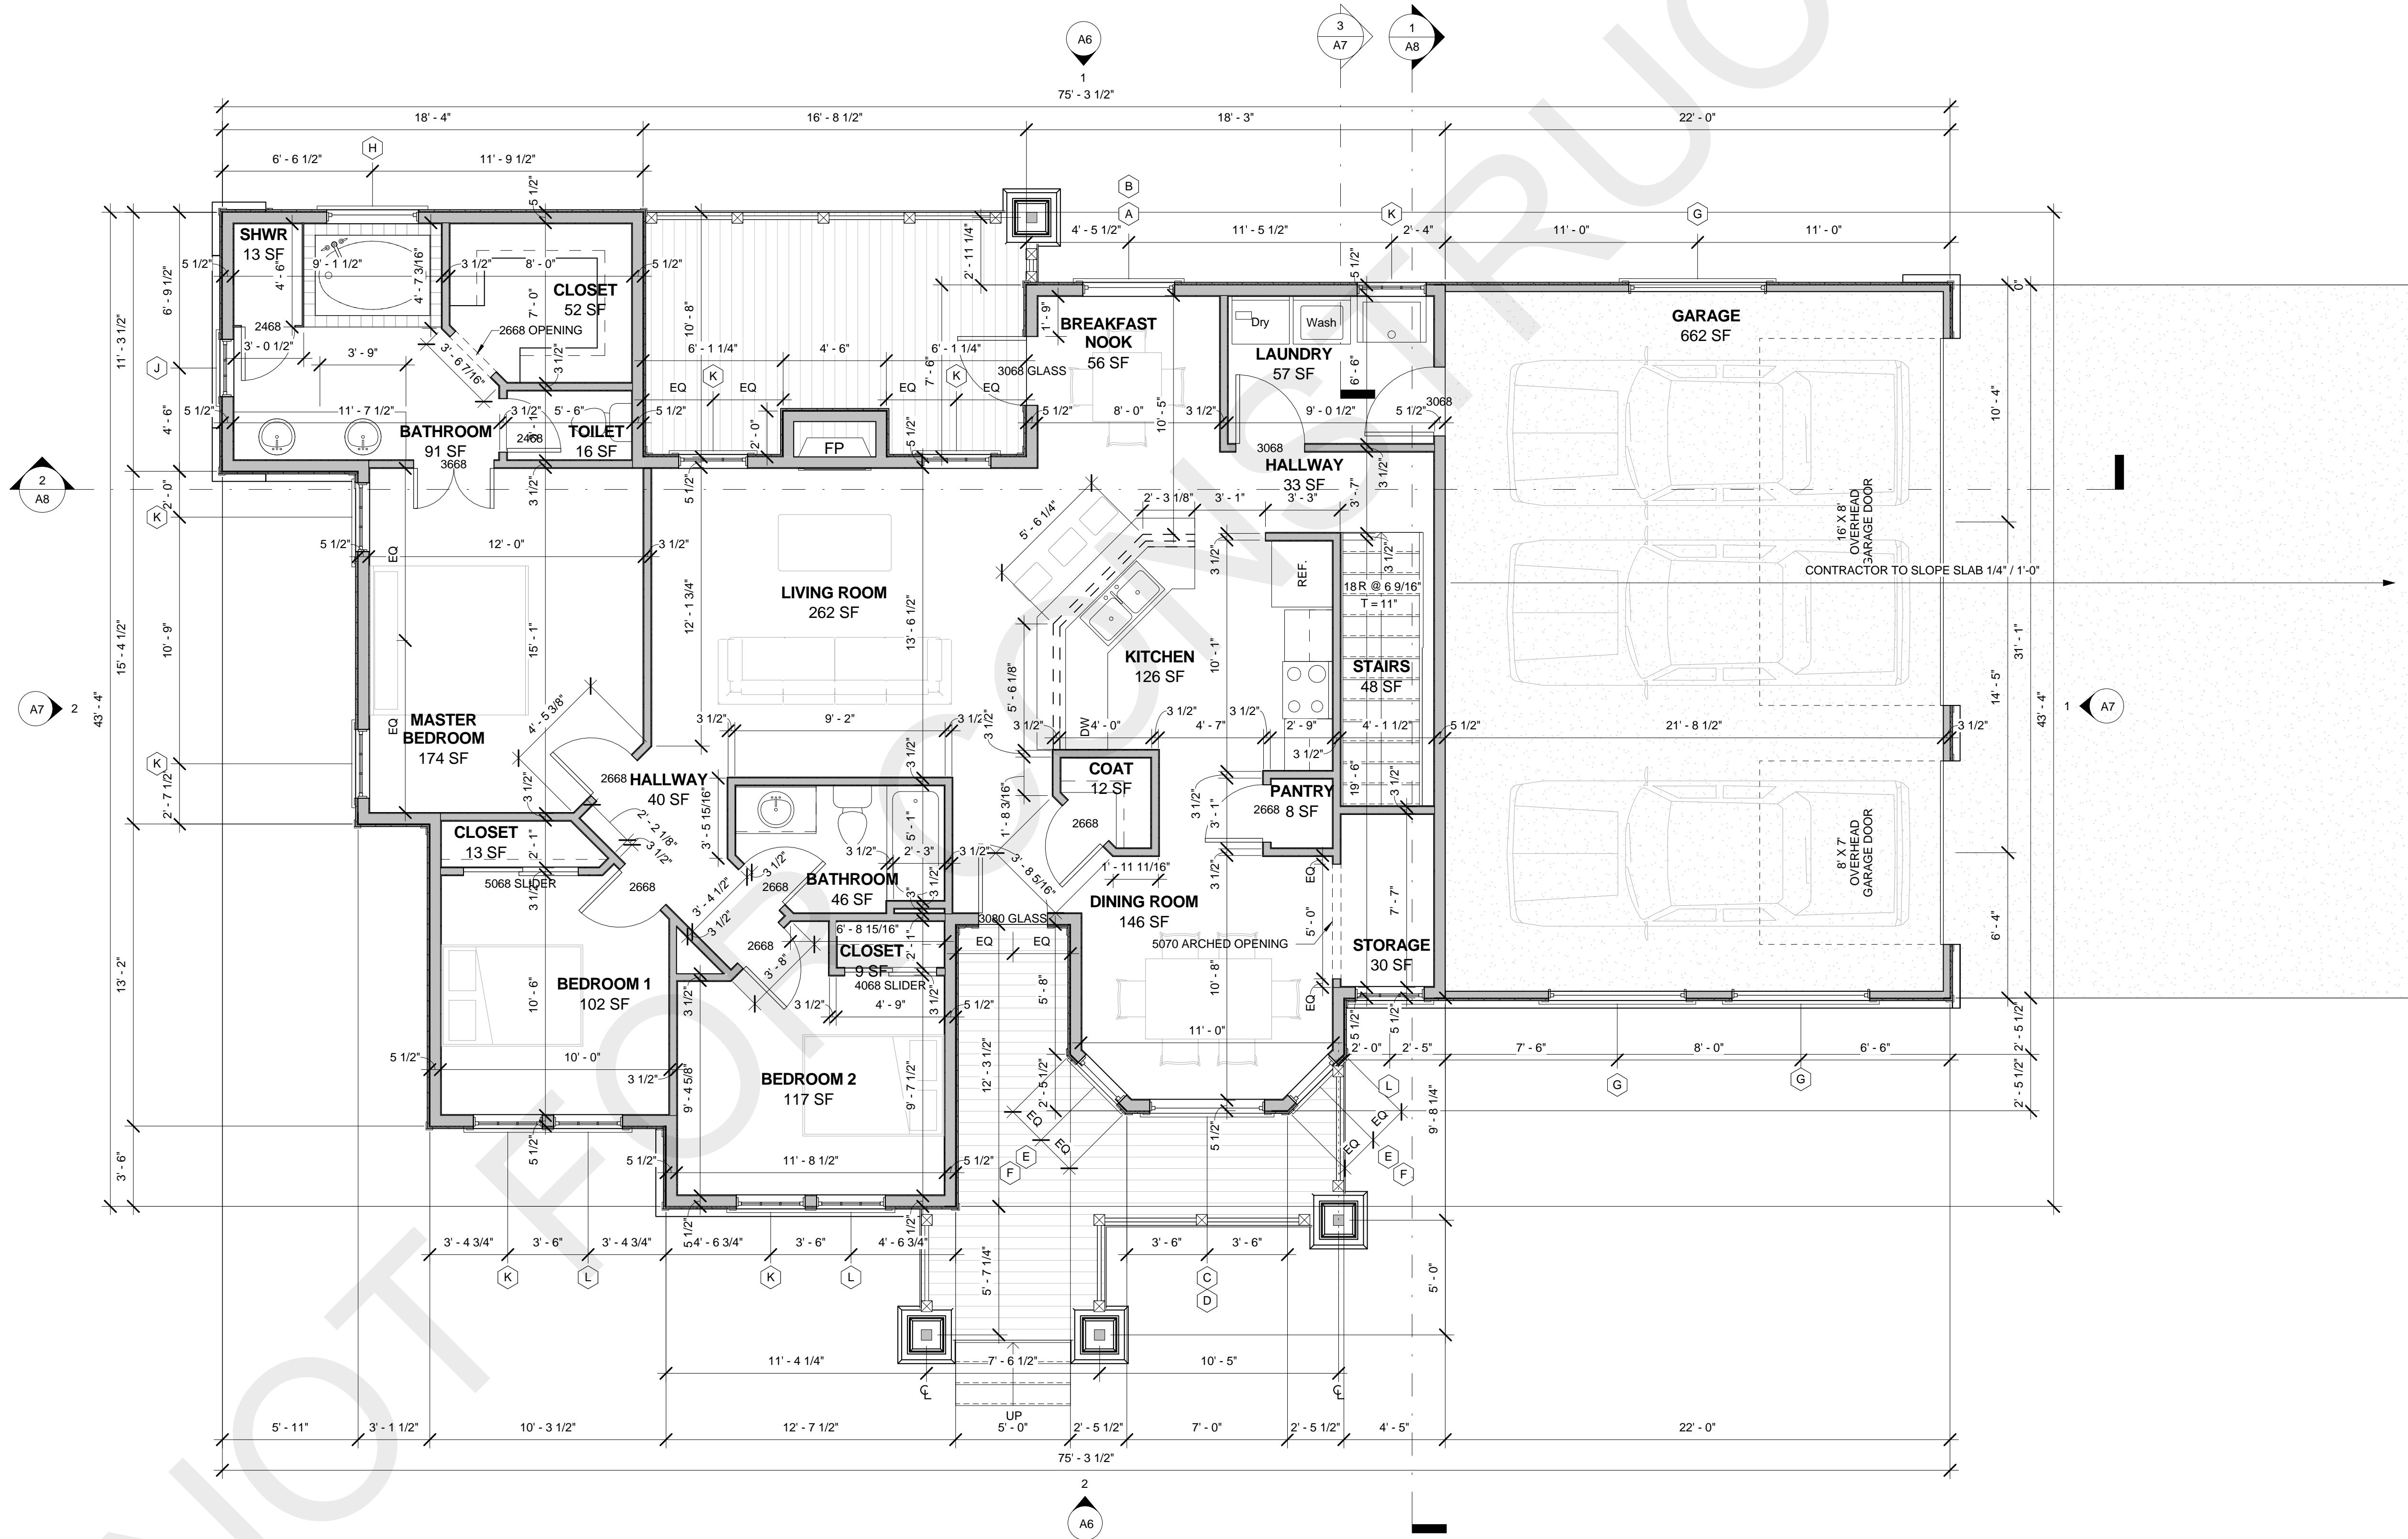


1 MAIN FLOOR PLAN
1/4" = 1'-0"


Drawn by LVC
Checked by DM
Project Date 00/00/2000
Project Number 000000

BUILDERS SET

John Doe Lane John Doe Town, John State 00000

1 ROOF PLAN
1/4" = 1'-0"


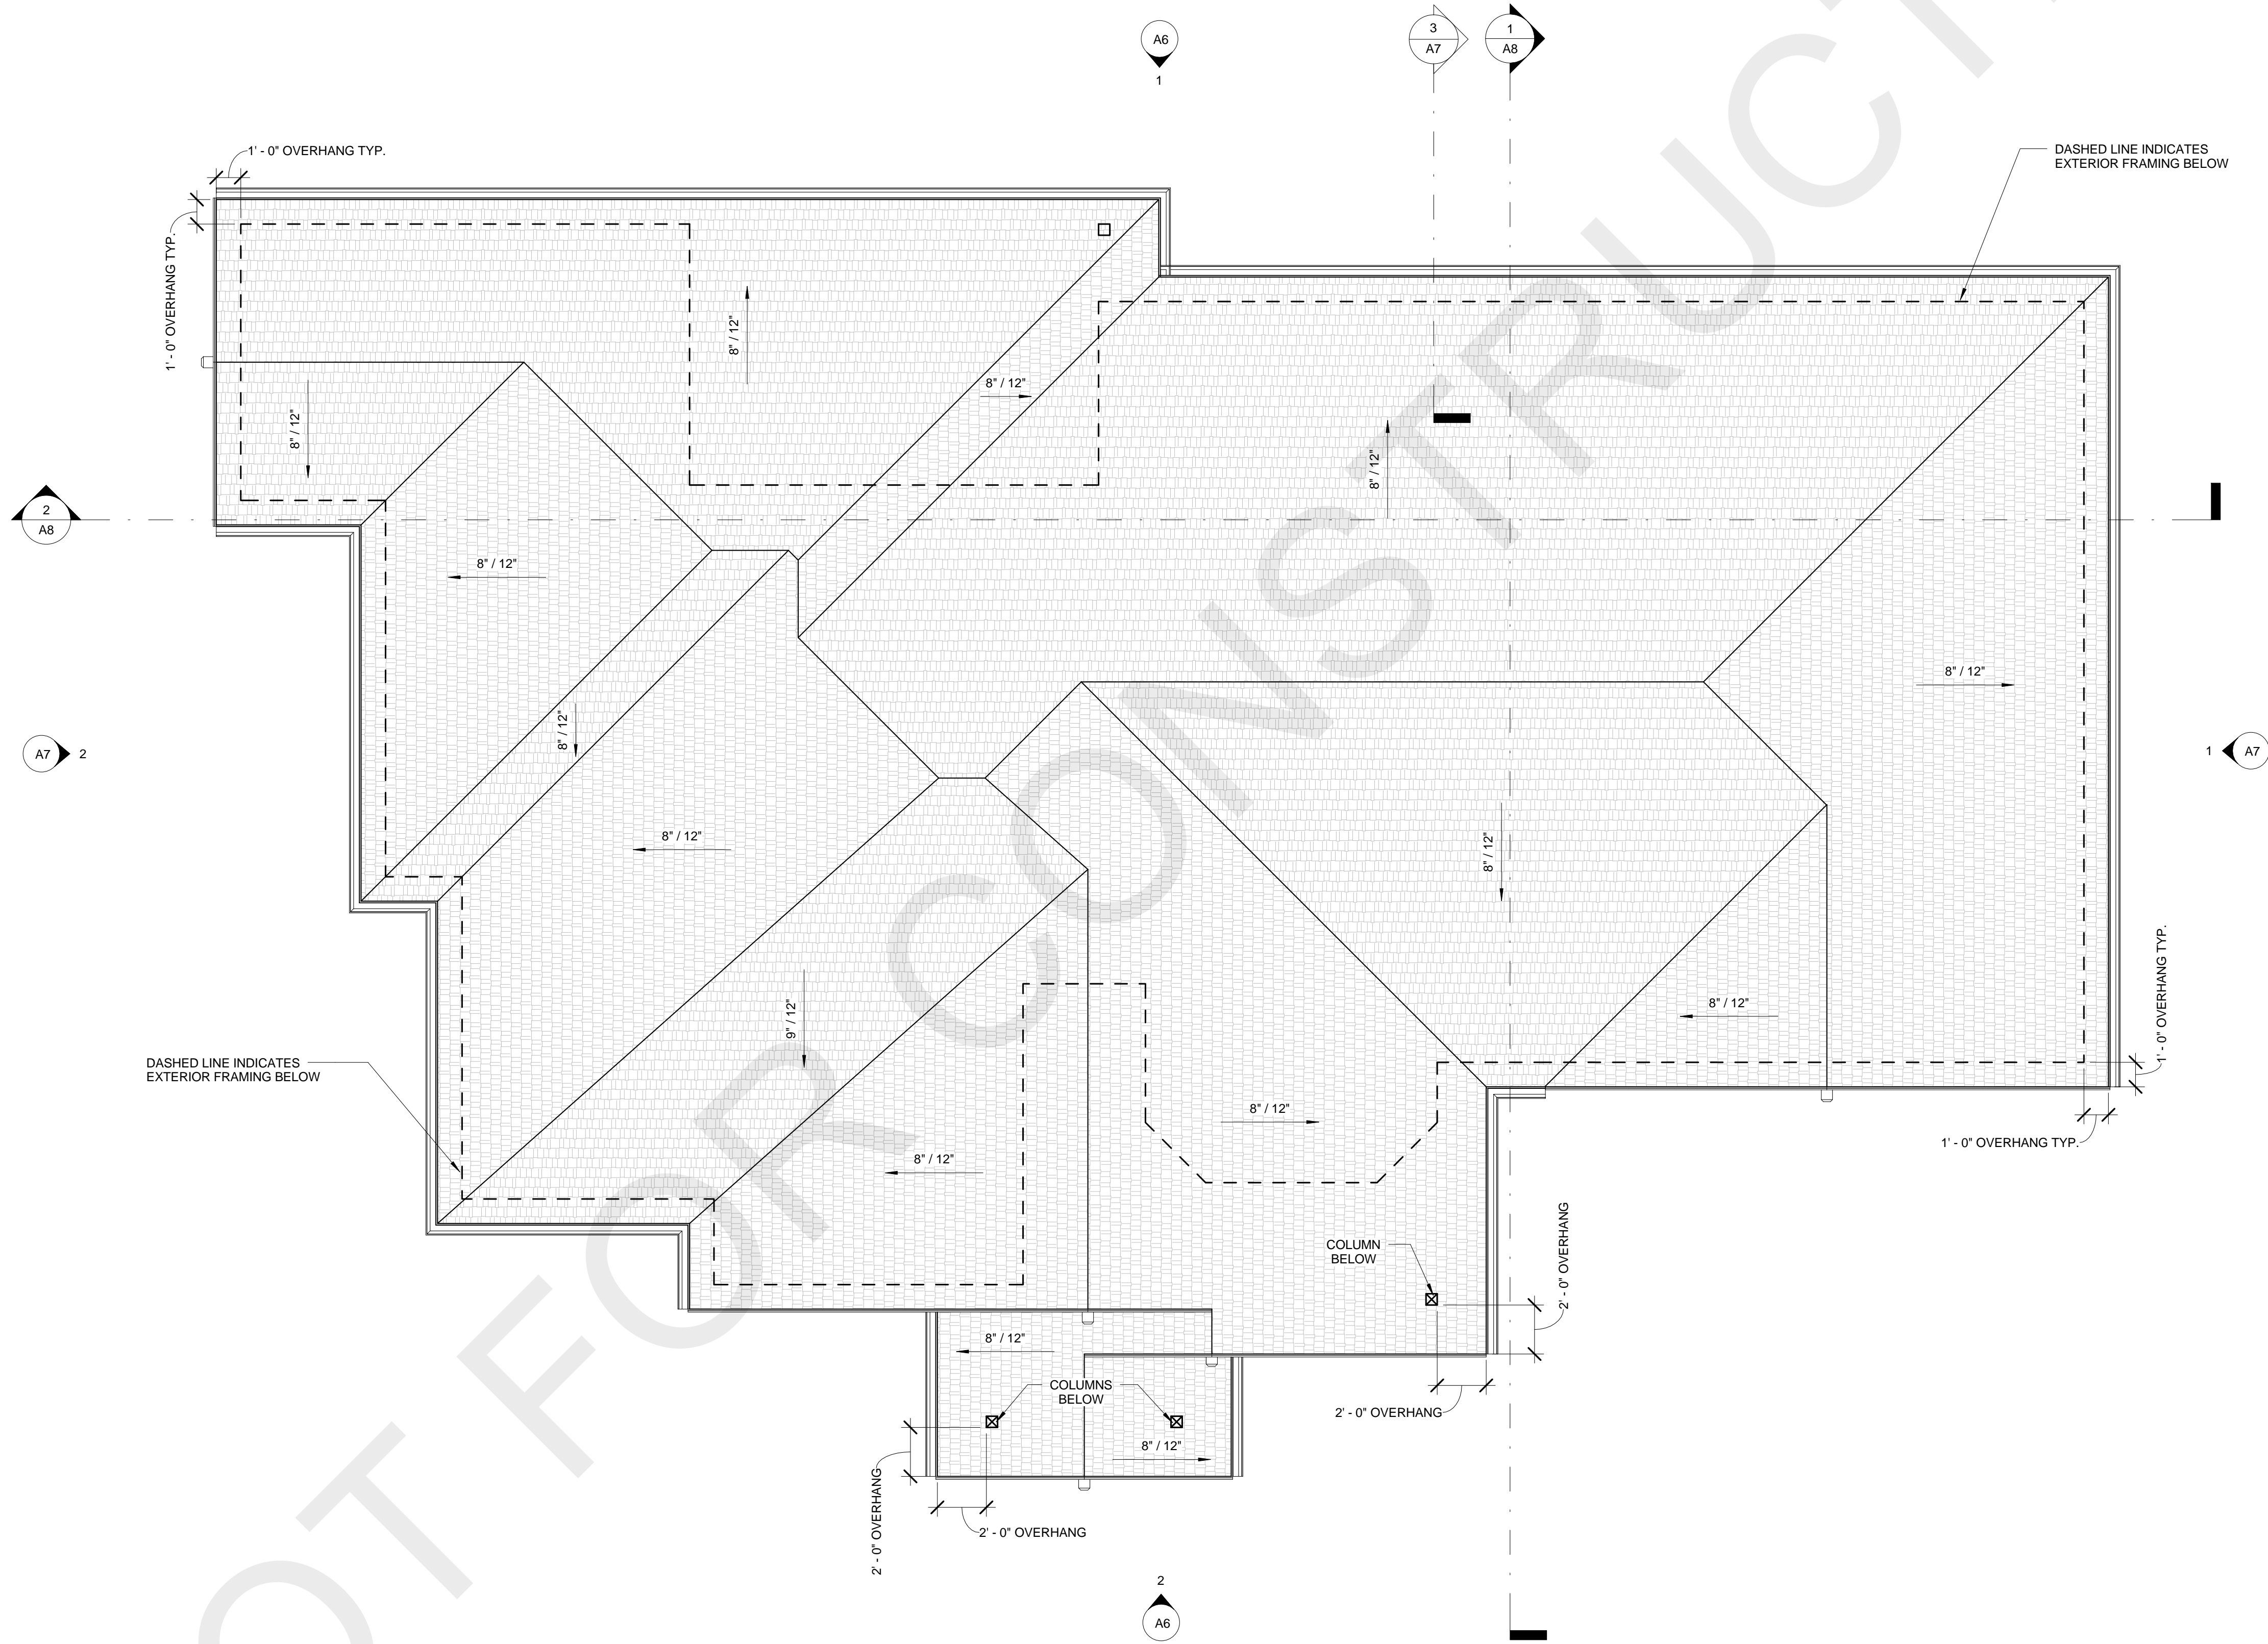




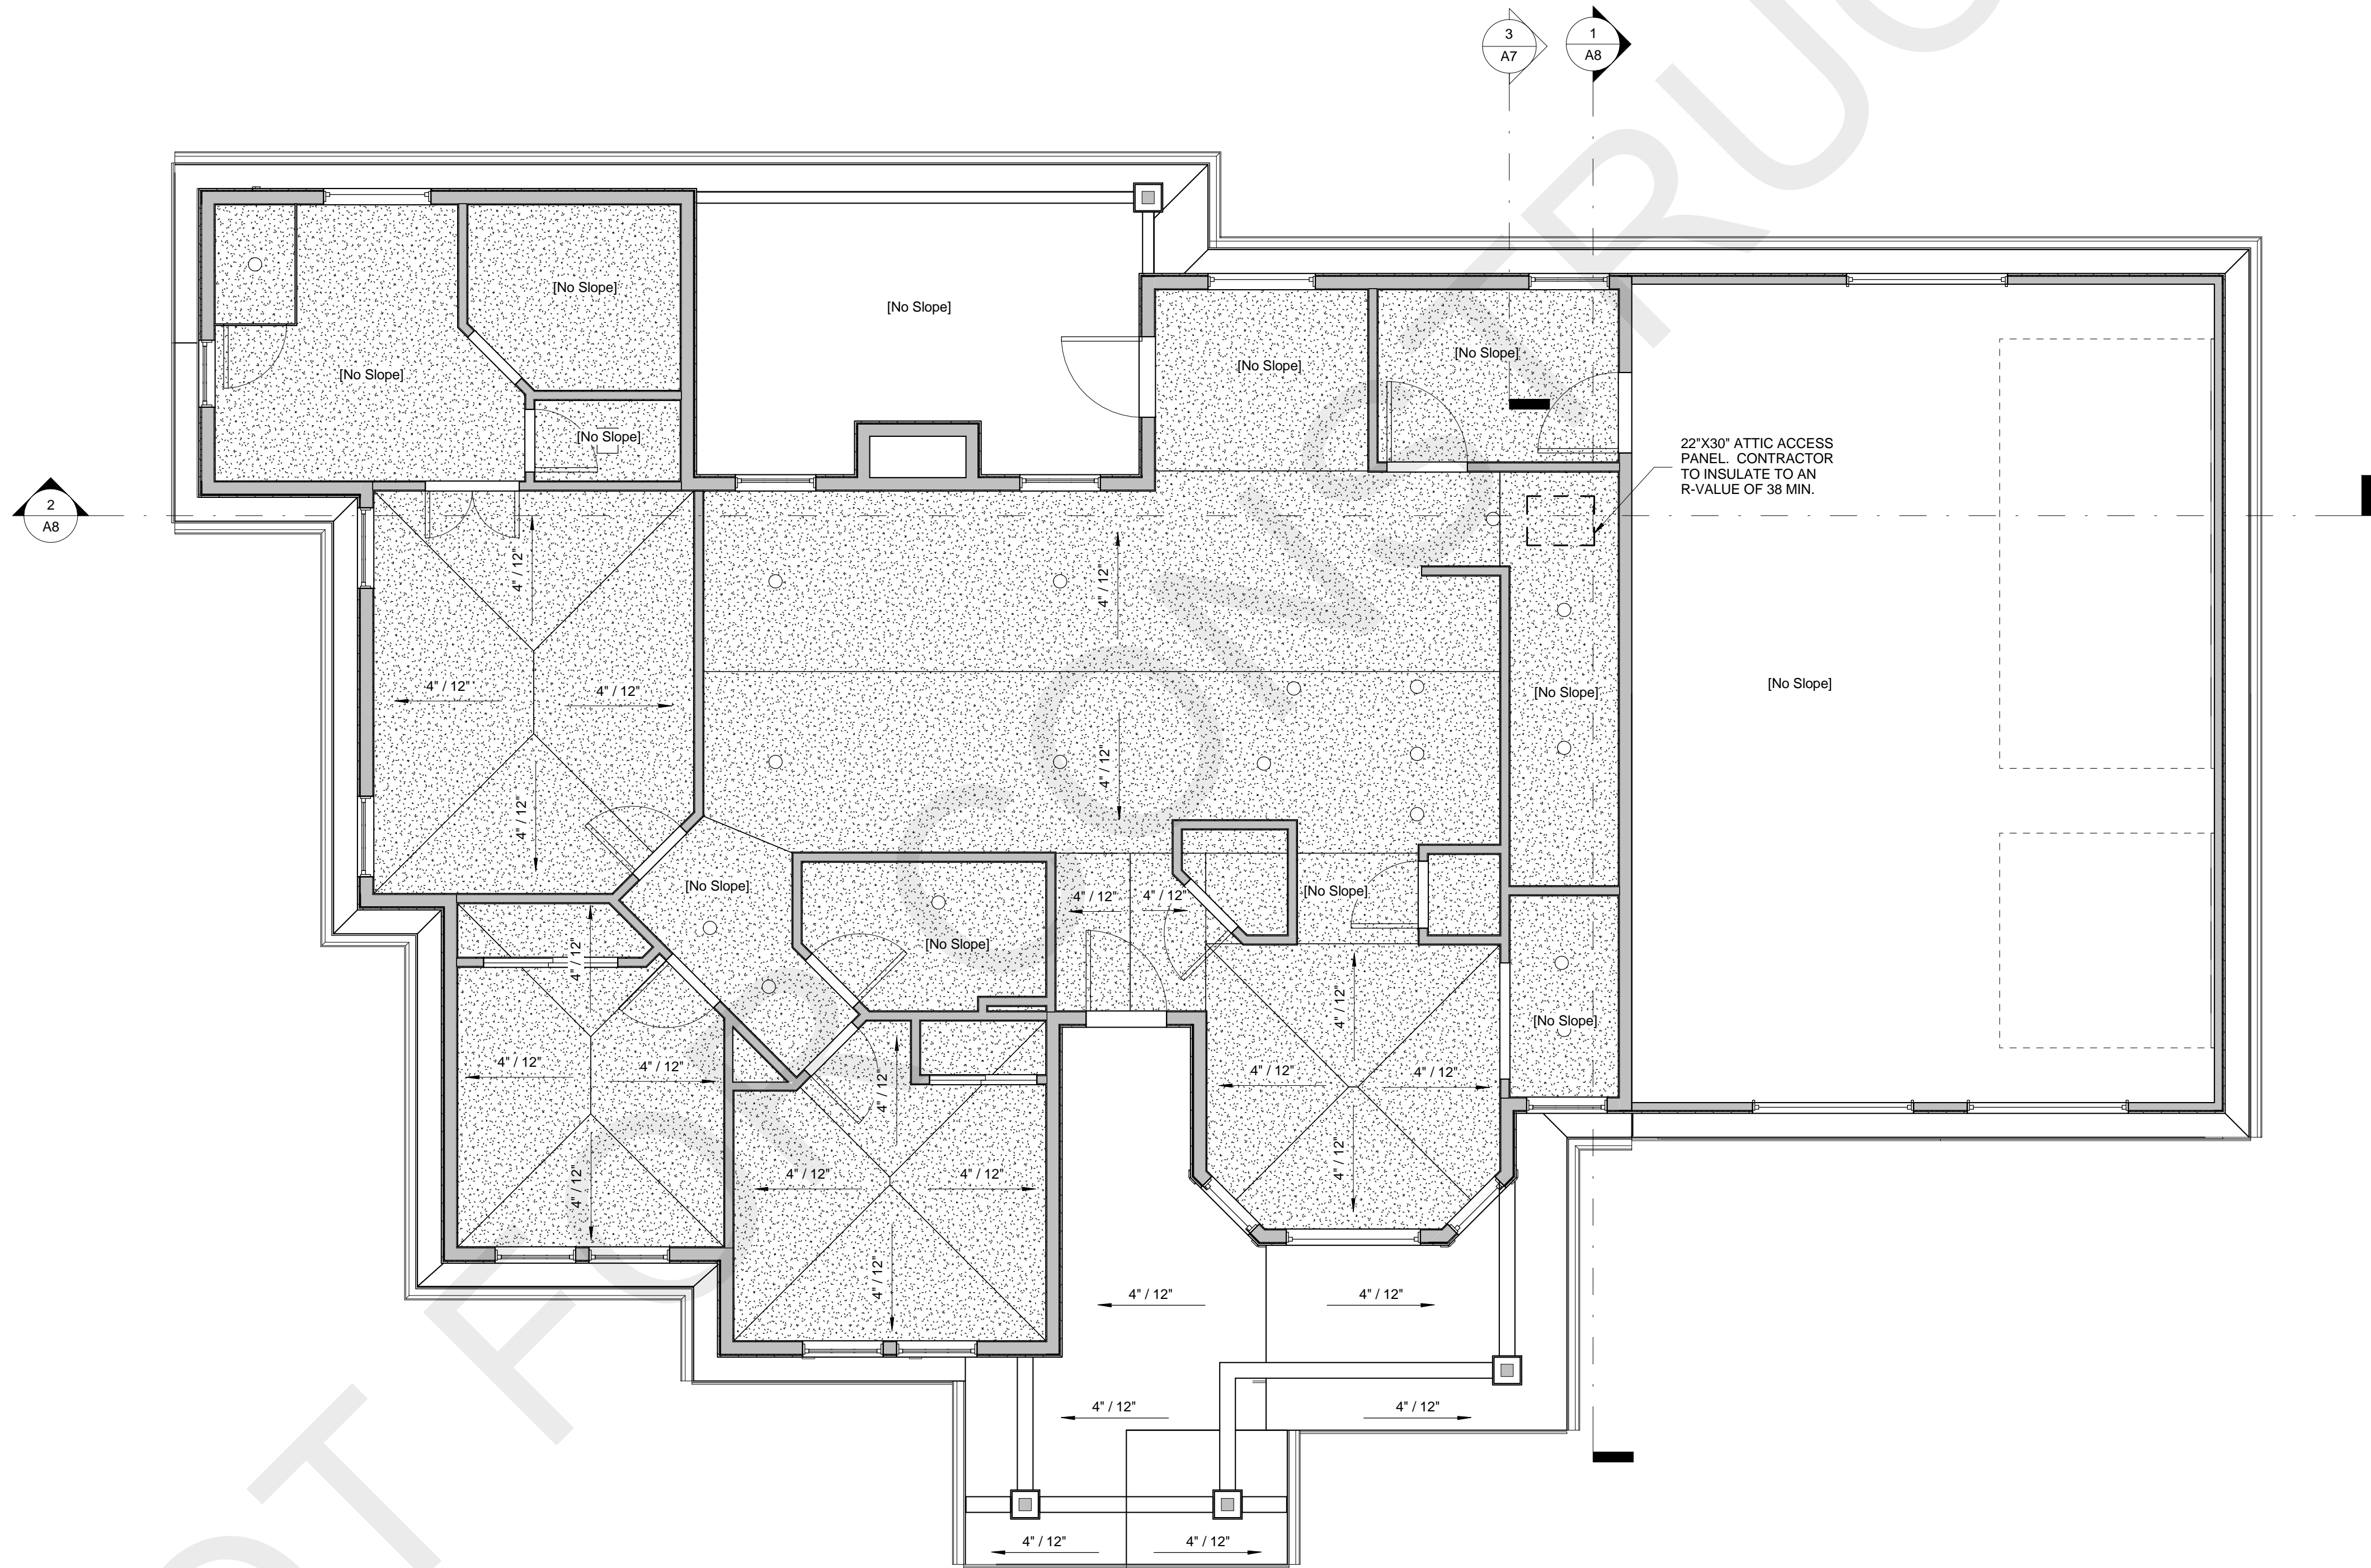



1 MAIN FLOOR - REFLECTED CEILING PLAN
1/4" = 1'-0"

Drawn by LVC
Checked by DM
Project Date 00/00/2000
Project Number 000000


BUILDERS SET
John Doe Lane John Doe Town, John State 00000

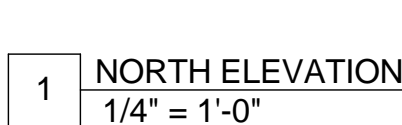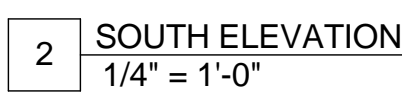

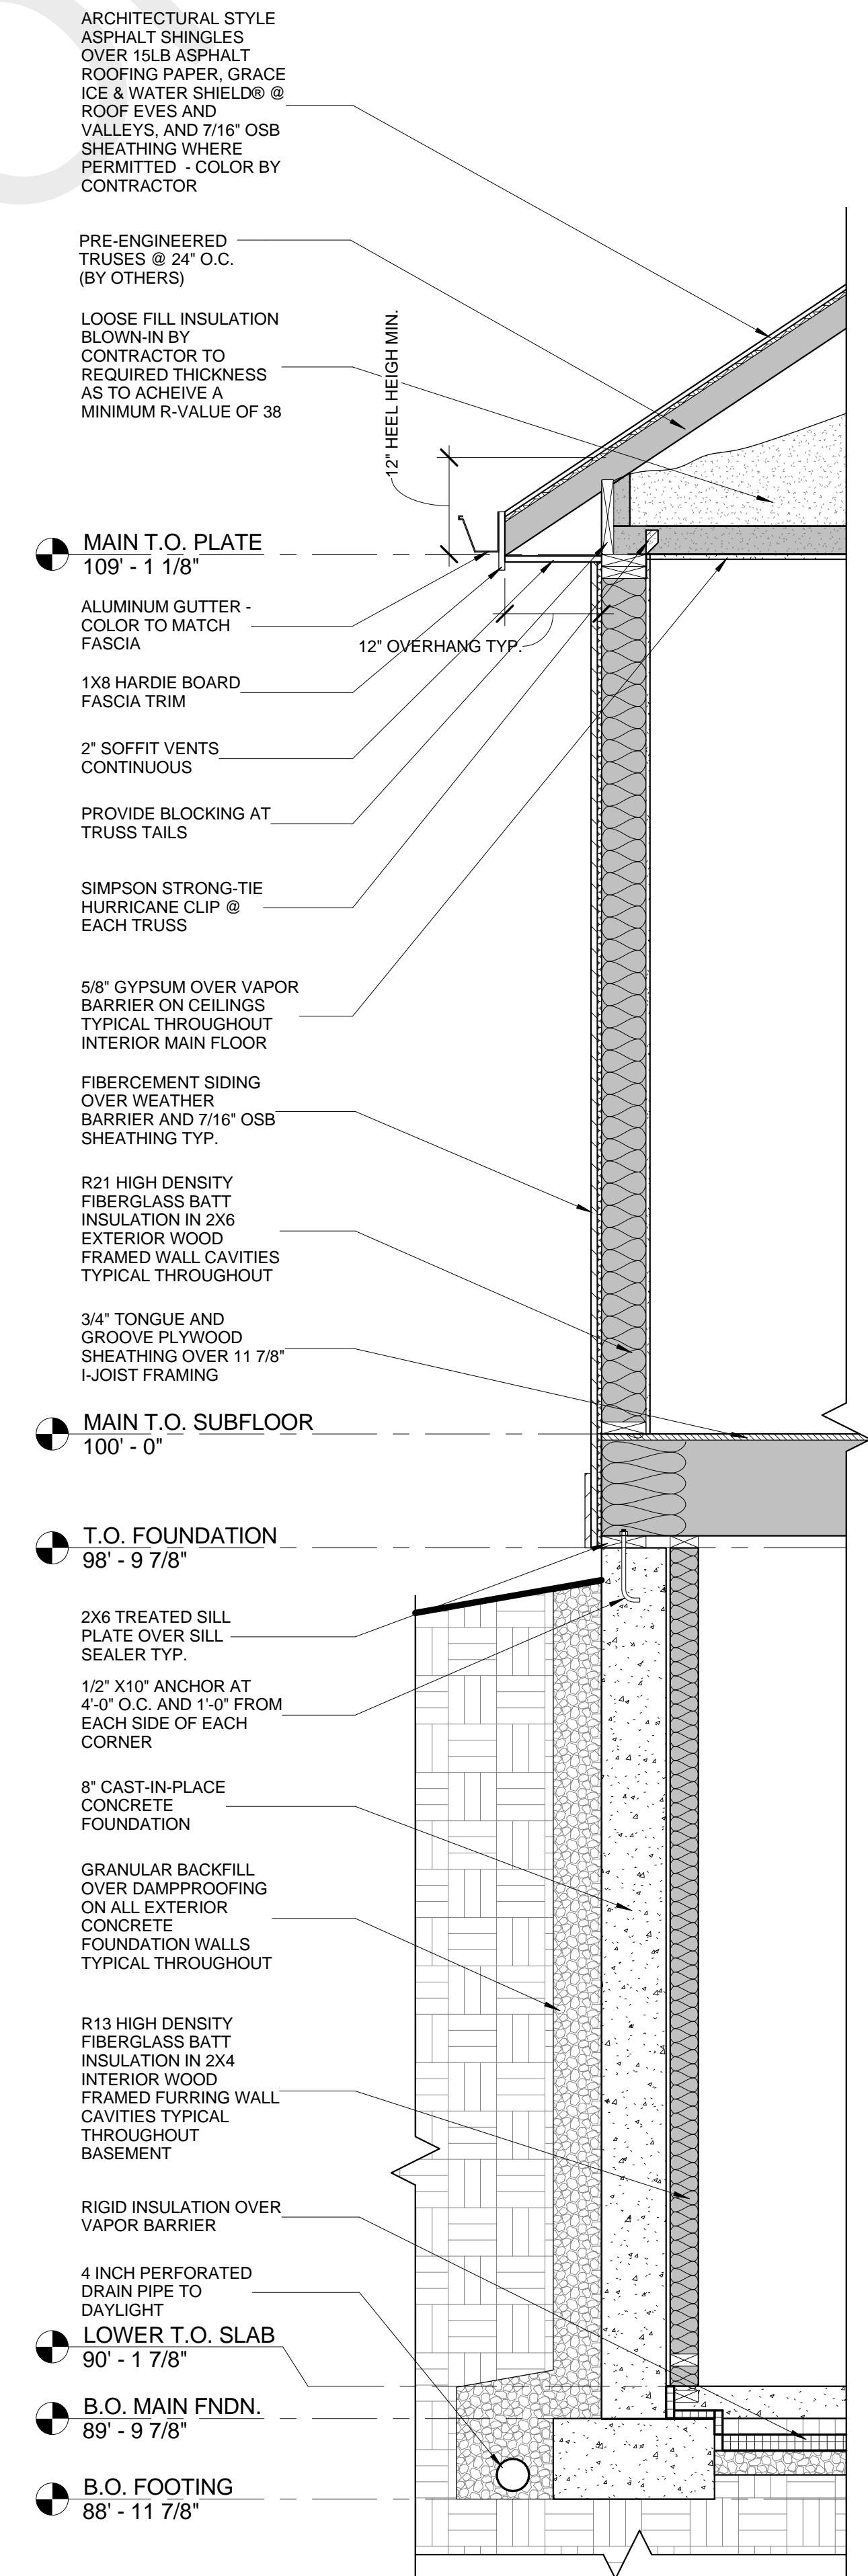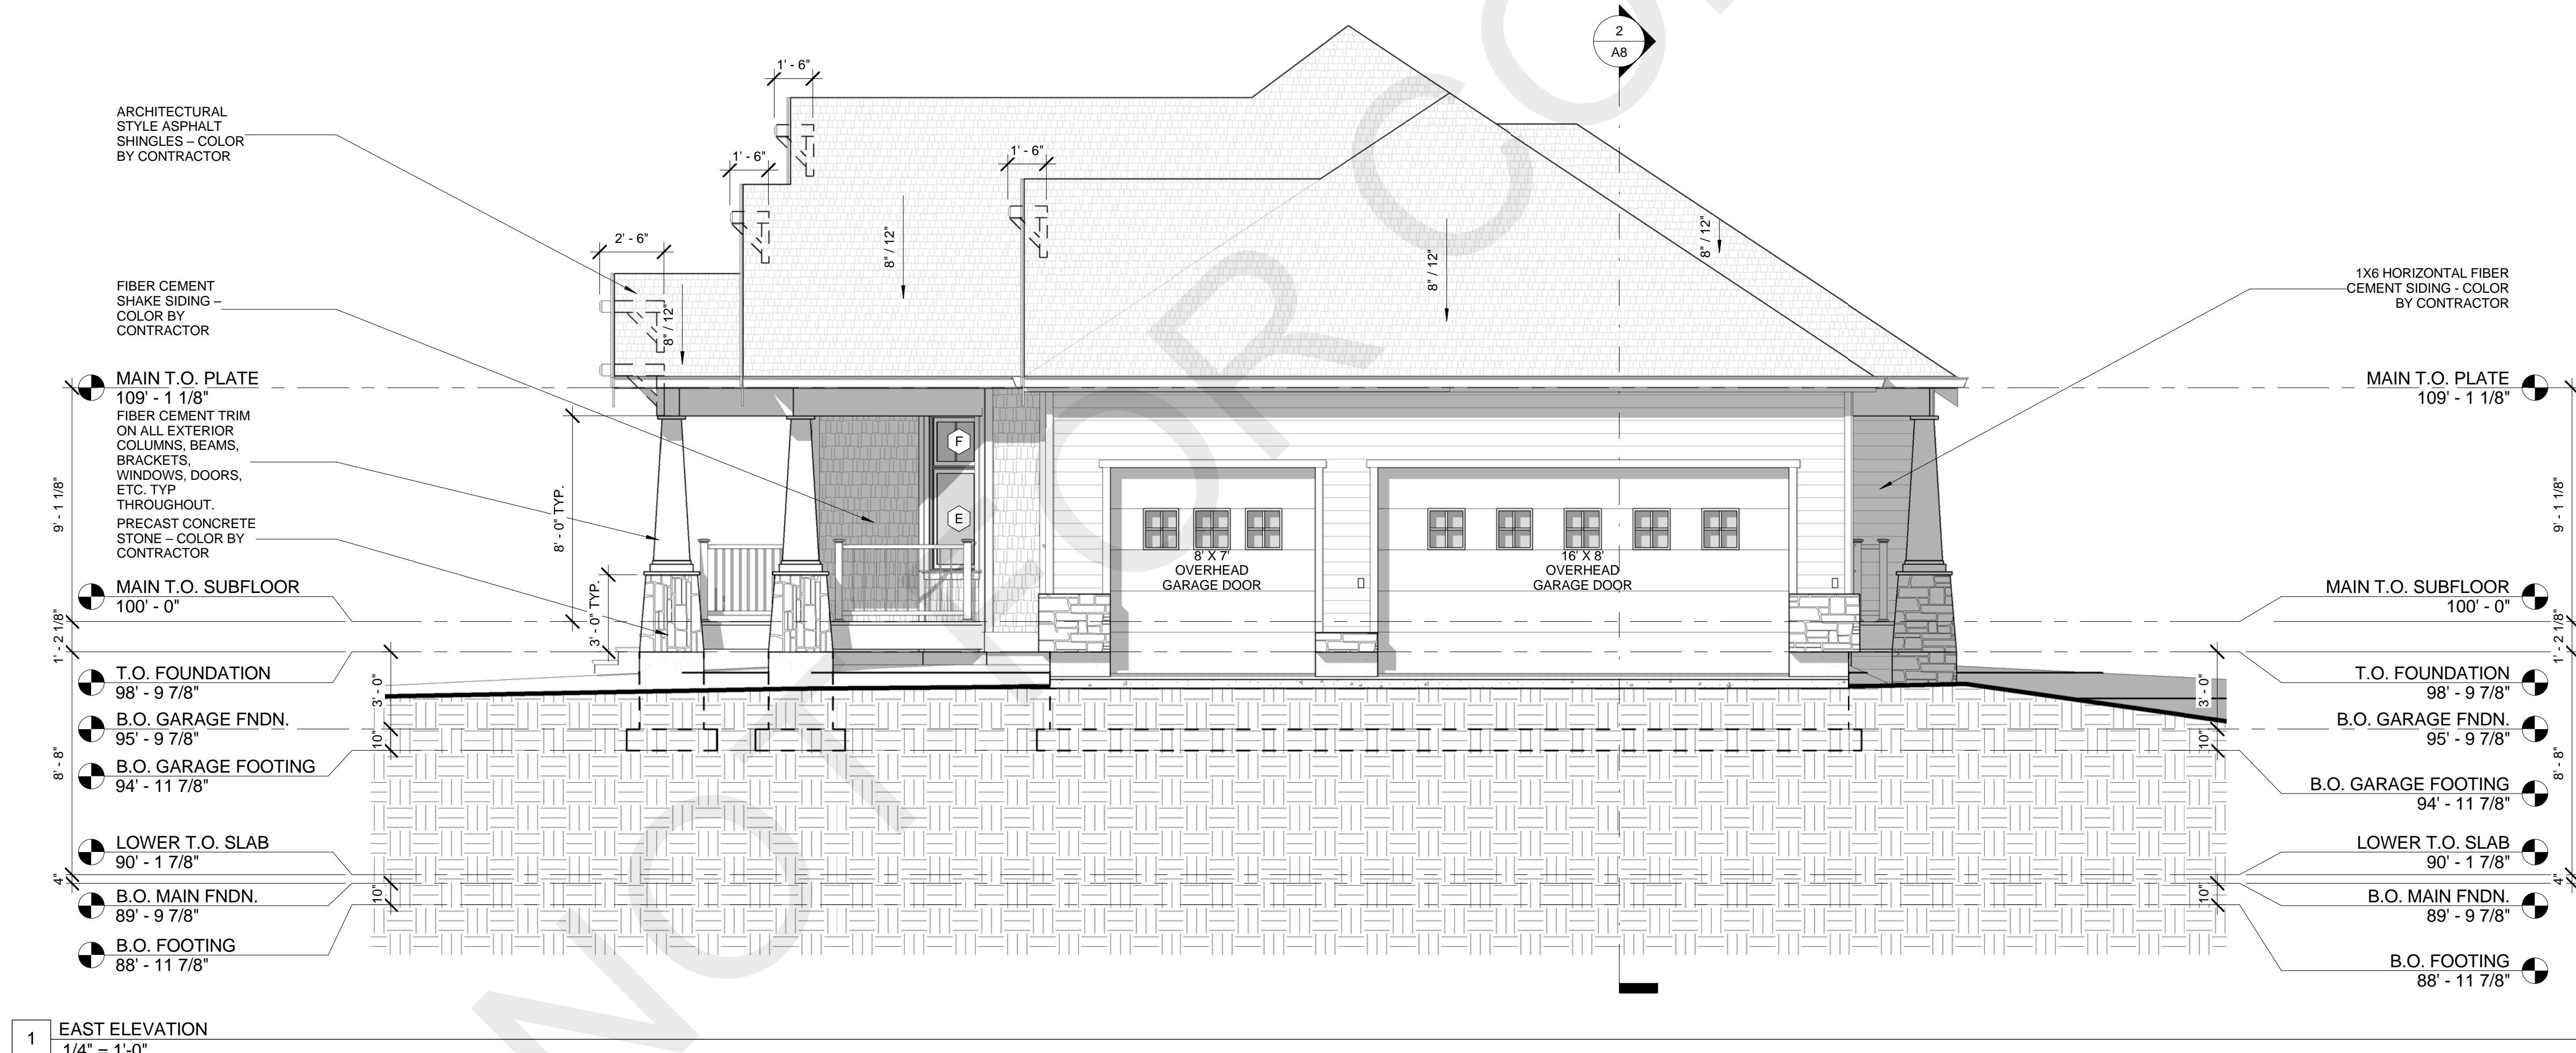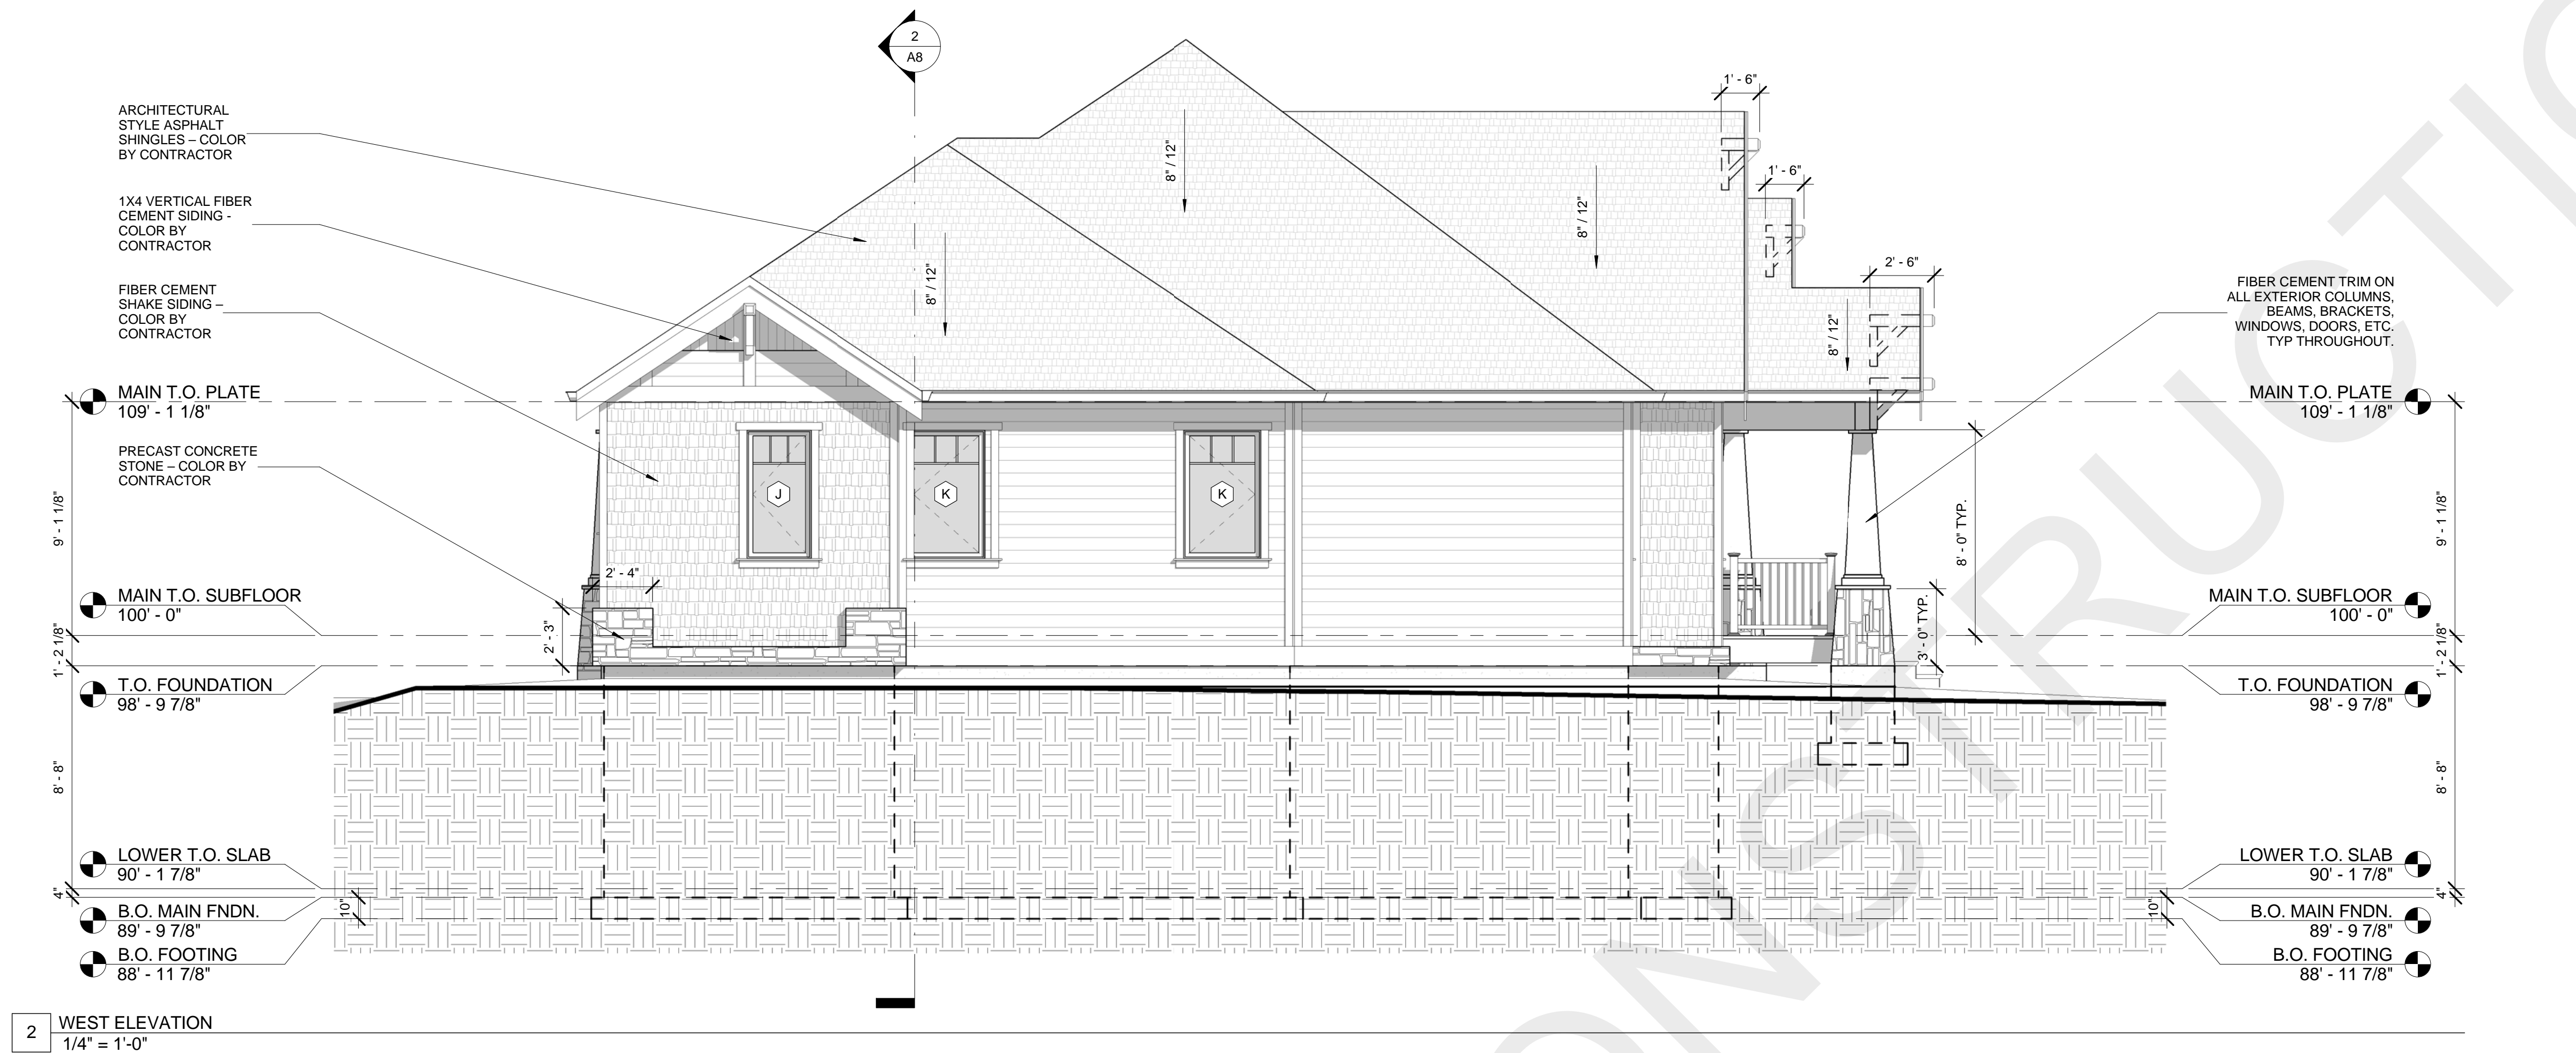

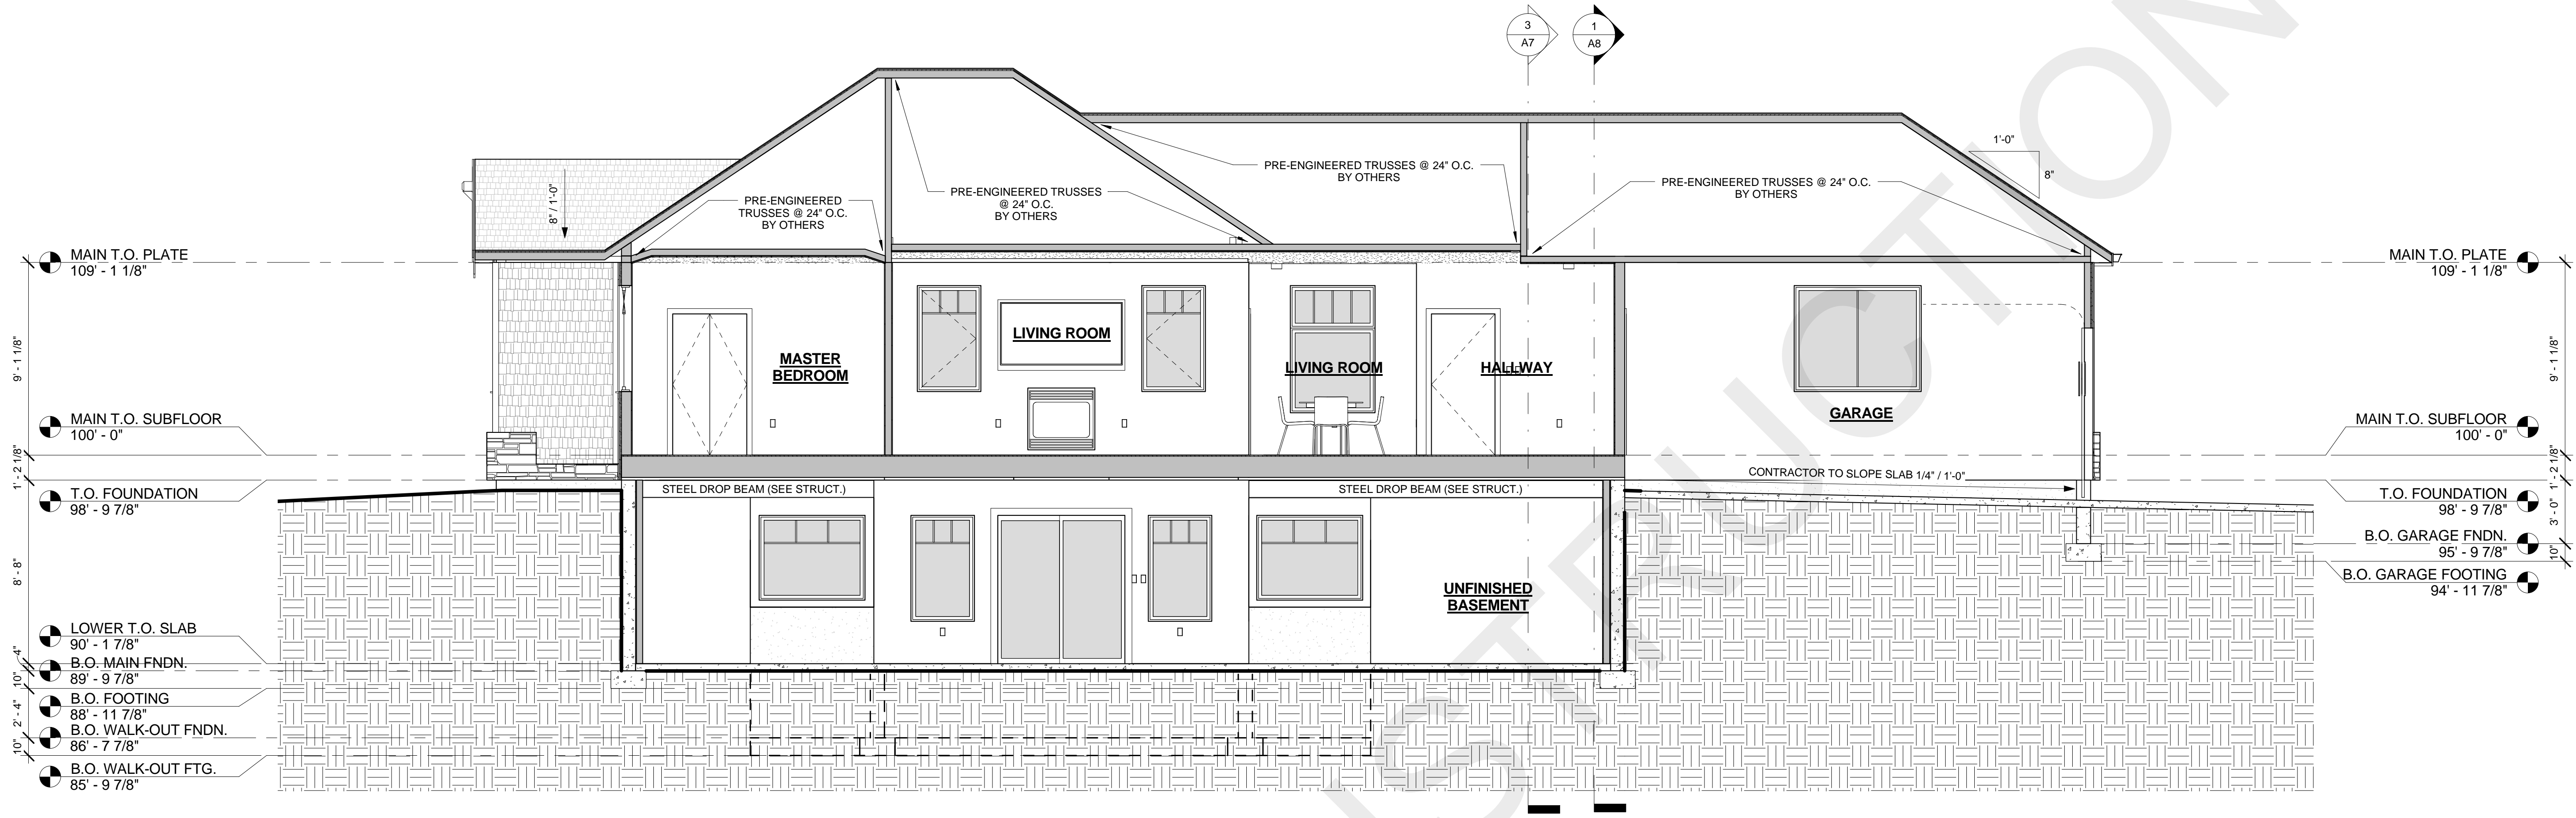

2 SECTION 2
1/4" = 1'-0"


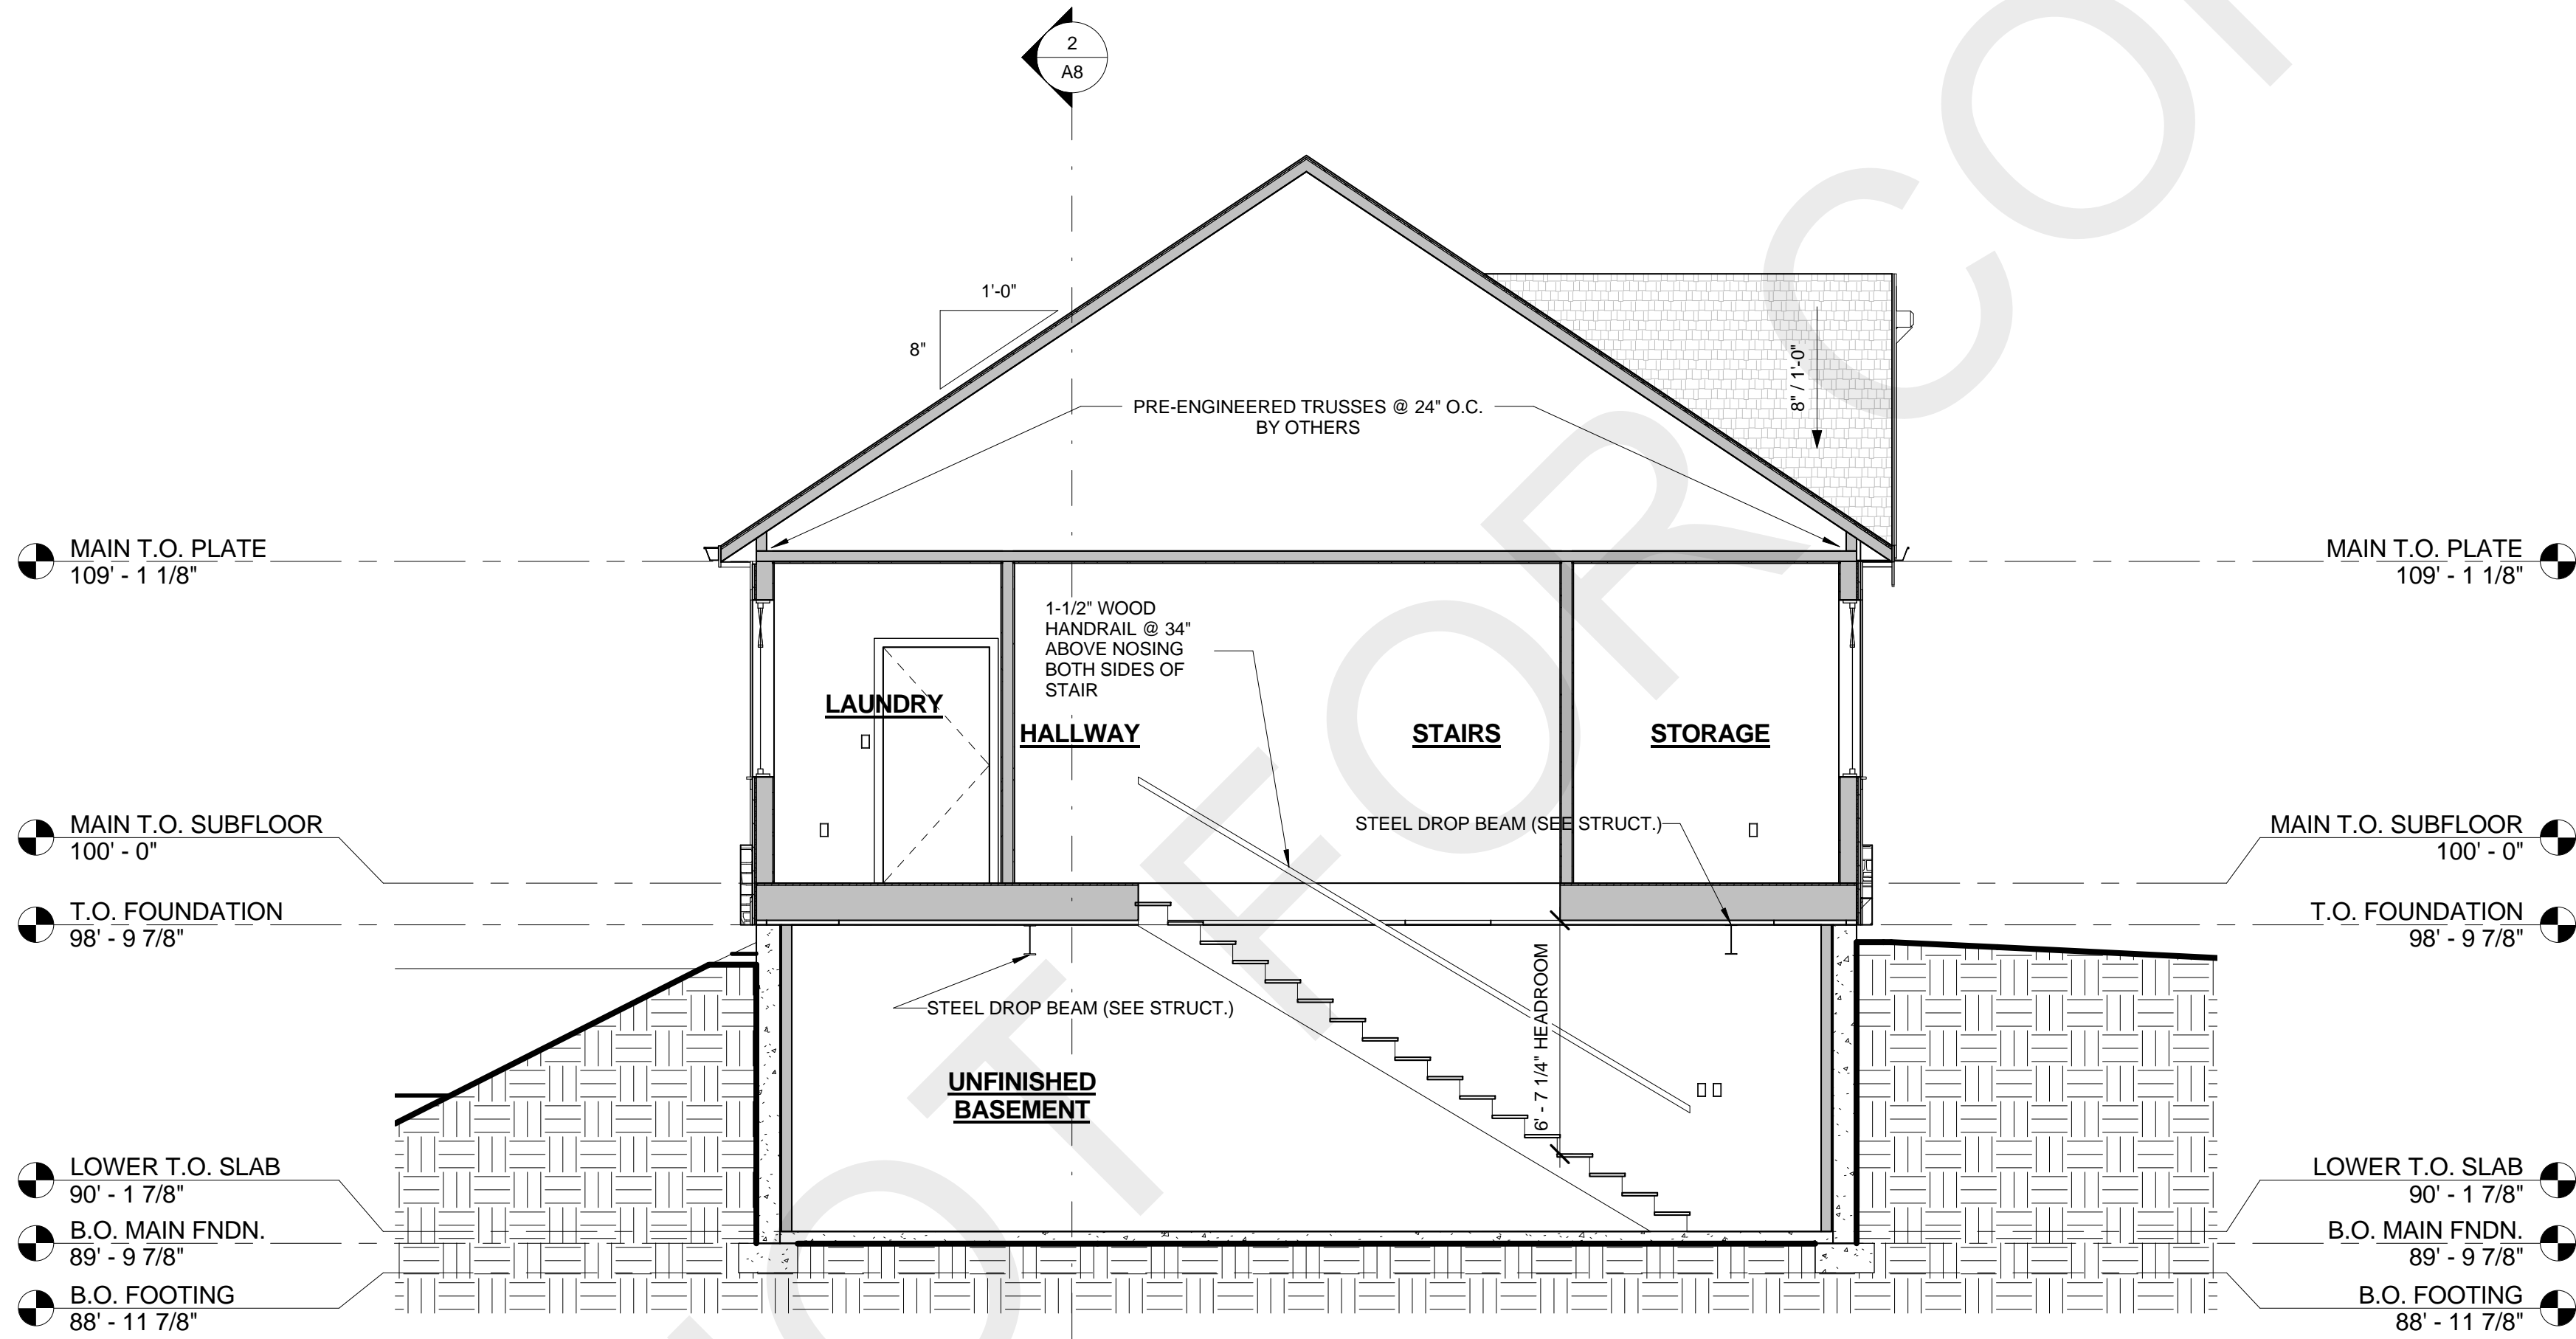


1 SECTION 1
1/4" = 1'-0"

Drawn by LVC
Checked by DM
Project Date 00/00/2000
Project Number 000000

BUILDERS SET



John Doe Lane John Doe Town, John State 00000

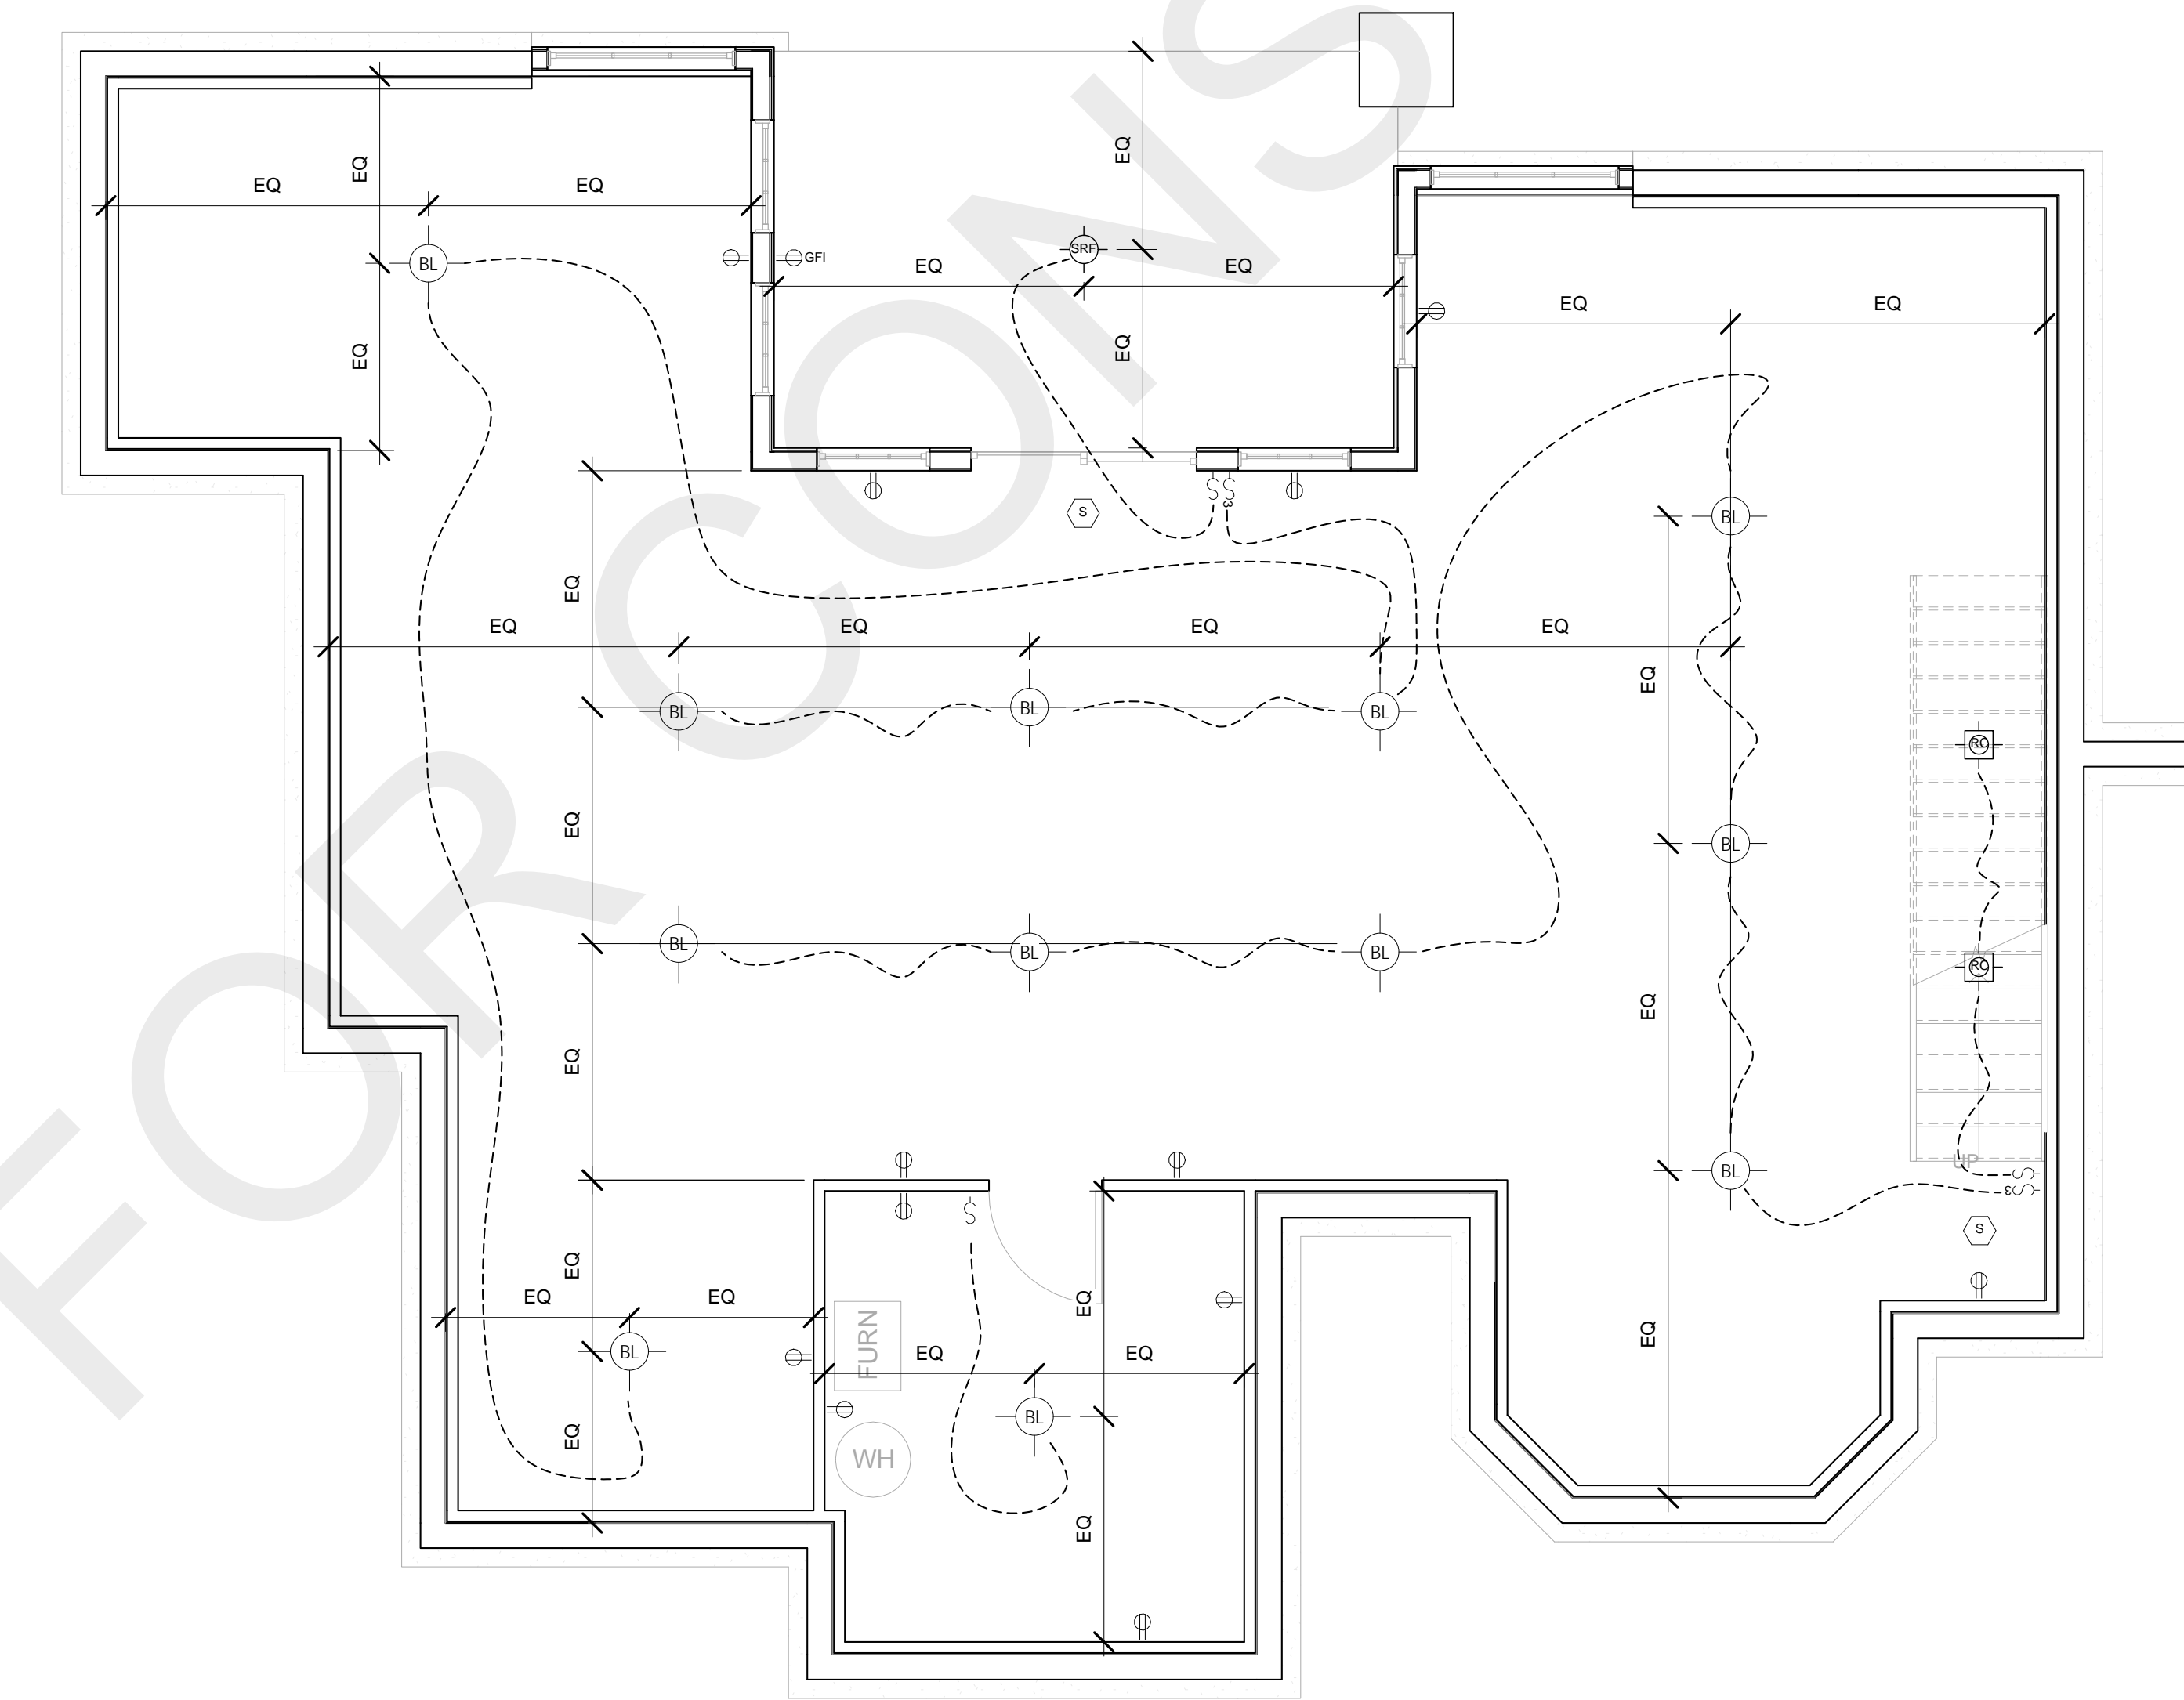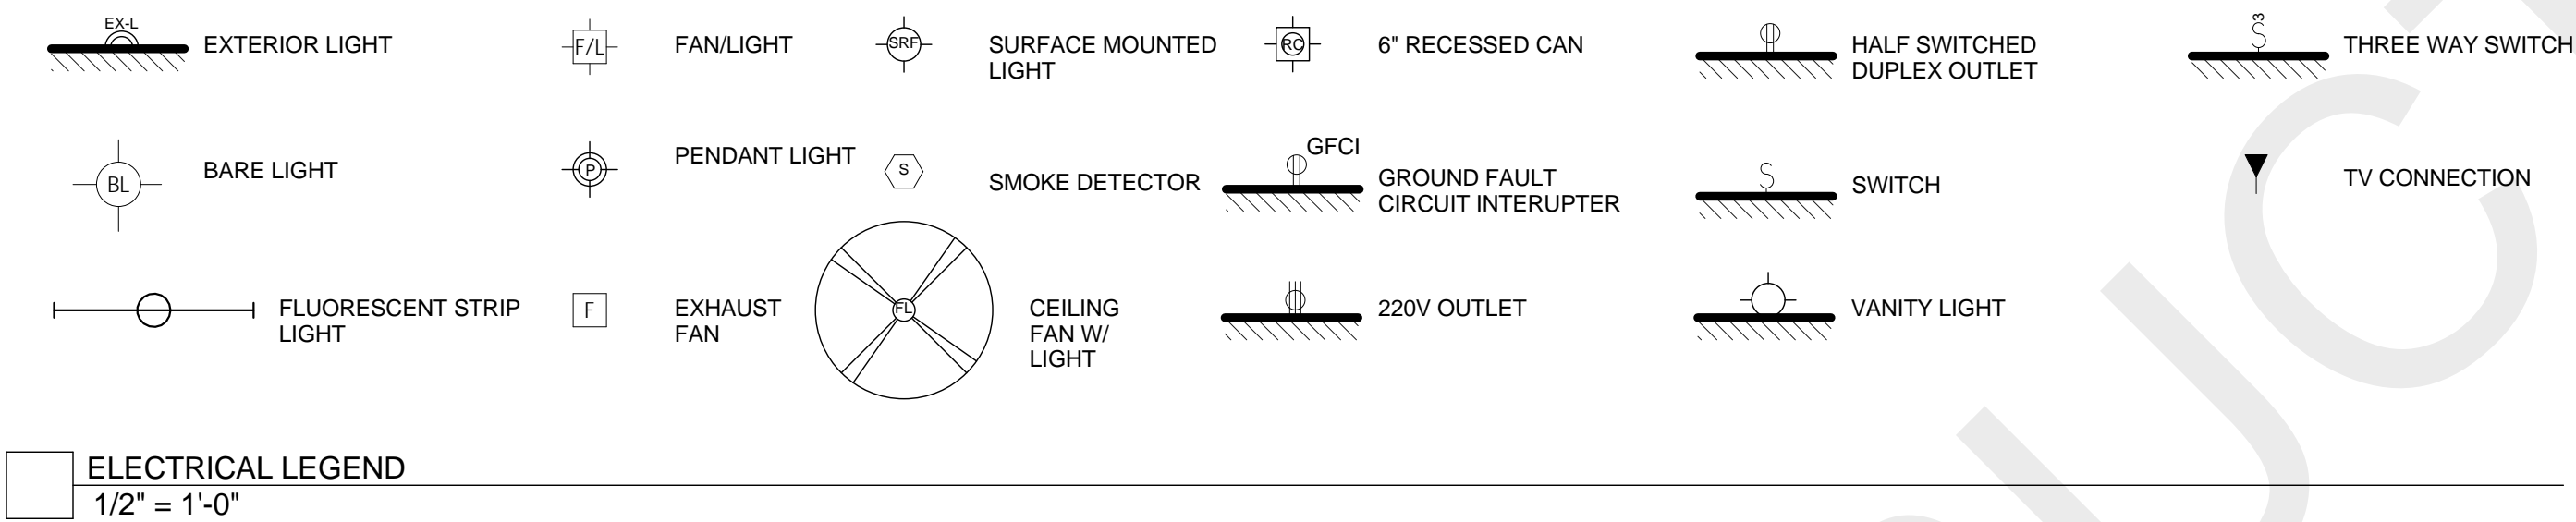

1 LOWER FLOOR - CONCEPTUAL ELECTRICAL PLAN
1/4" = 1'-0"

Drawn by LVC
Checked by DM
Project Date 00/00/2000
Project Number 000000

BUILDERS SET
John Doe Lane John Doe Town, John State 00000

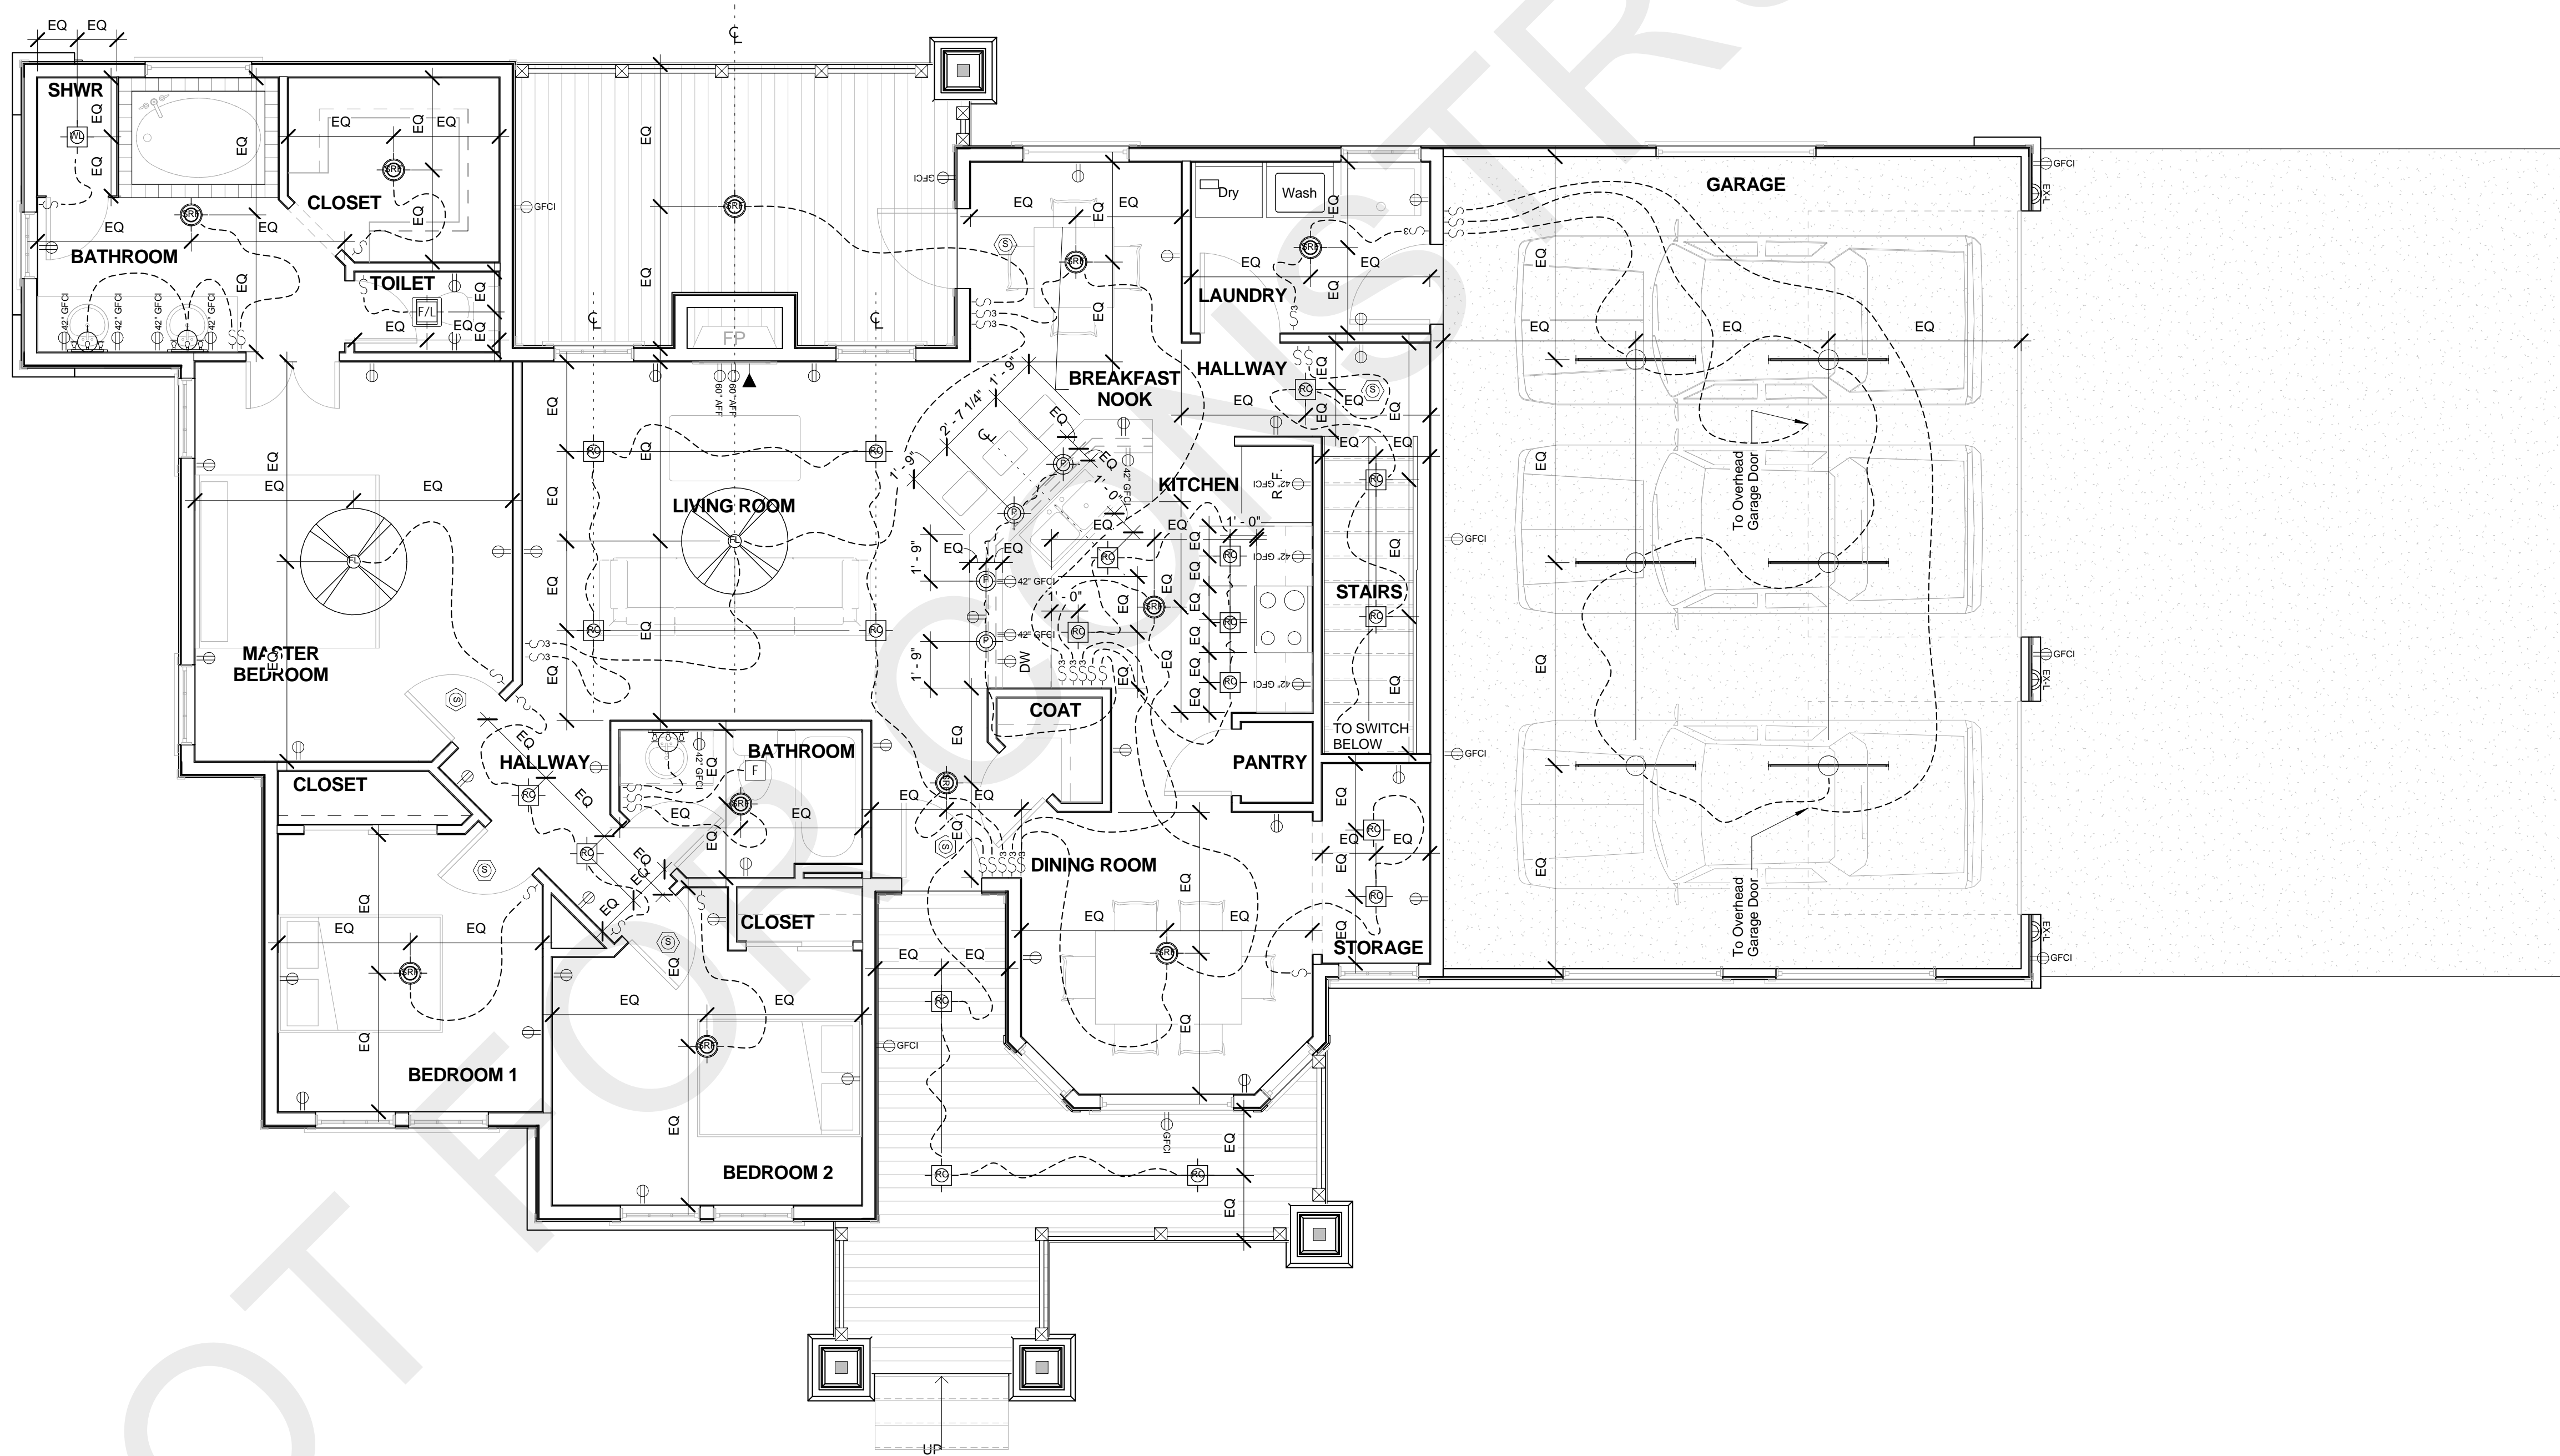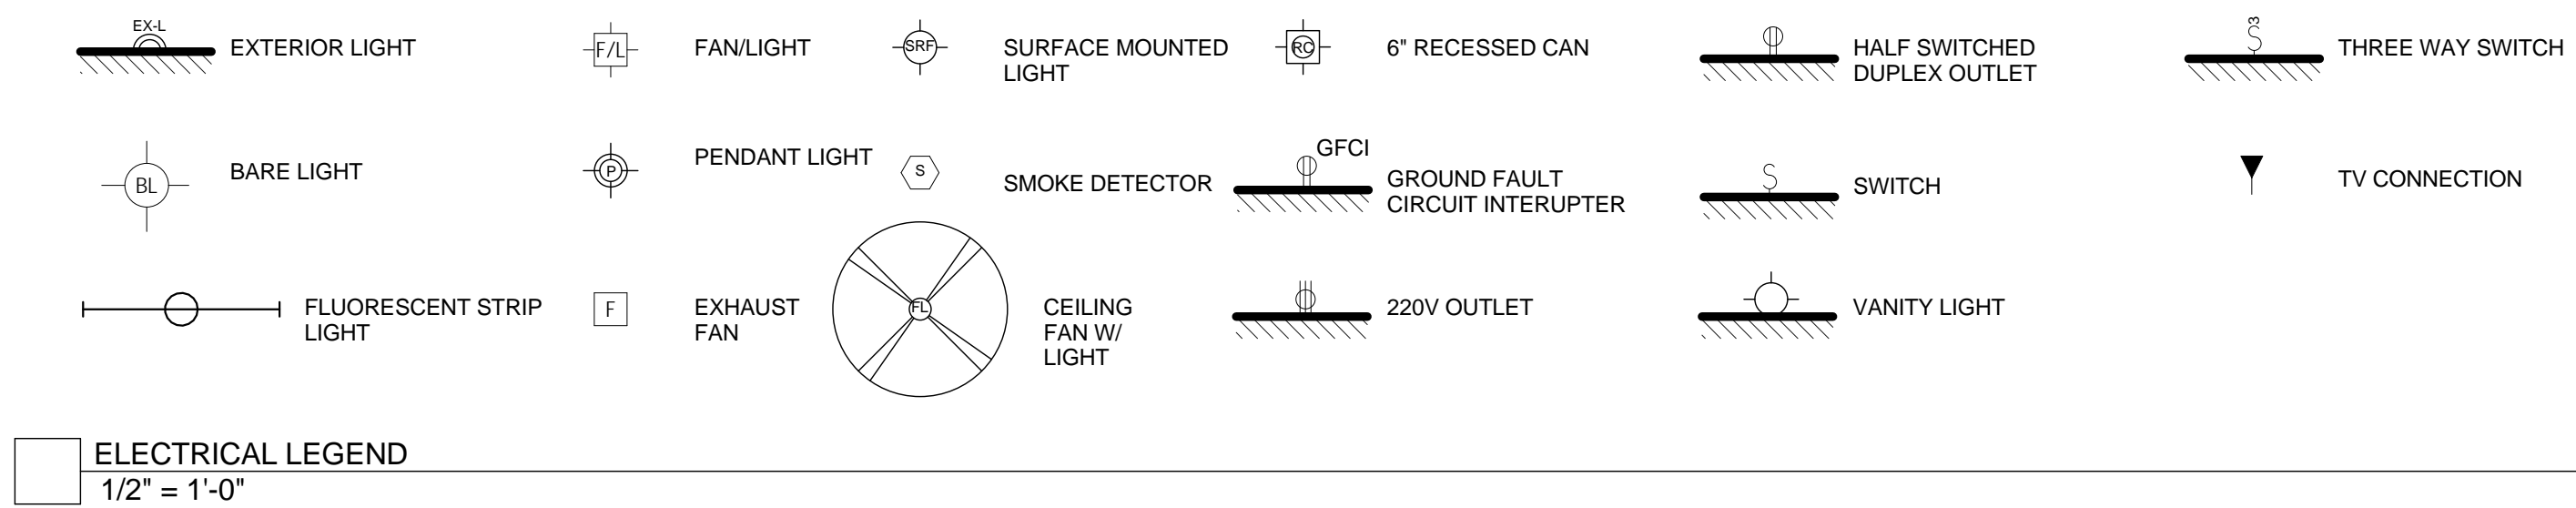

1 MAIN FLOOR - CONCEPTUAL ELECTRICAL PLAN
1/4" = 1'-0"

Drawn by LVC
Checked by DM
Project Date 00/00/2000
Project Number 000000

BUILDERS SET

John Doe Lane John Doe Town, John State 00000